

CITY OF JOLIET, ILLINOIS

MILLS ROAD WATER MAIN IMPROVEMENTS CITY OF JOLIET CONTRACT NO. 2441-0220 IEPA LOAN NO. L17-5430

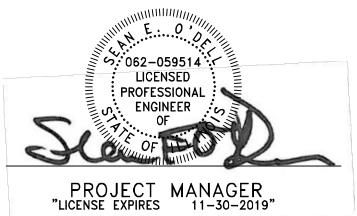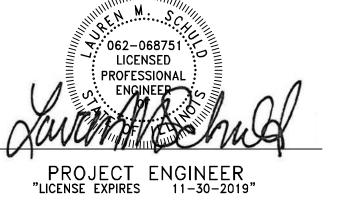

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J.U.L.I.E. DESIGN STAGE REQUEST

LOCATION OF UNDERGROUND UTILITY FACILITIES, SUCH

THE UTILITY LOCATIONS WERE DETERMINED FROM THE BEST

OR THE MANNER IN WHICH THEY ARE TO BE REMOVED OR

UTILITY COMPANIES FOR REMOVING OR ADJUSTING THE

DIG NO. X0850490 **EXISTING UTILITIES:**

FACILITIES.


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DATE: 10-23-19





ABBREVIATIONS

CONC	PORTLAND CEMENT CONCRETE	C&G	CURB AND GUTTER	X=	EXTERNAL DISTANCE OF VERTICAL CURVE
CL	CENTERLINE	ВС	BACK OF CURB	PC	POINT OF CURVATURE
BIT	BITUMINOUS PAVEMENT	EOP	EDGE OF PAVEMENT	PI	POINT OF INTERSECTION
GR	GRAVEL	PL	PROPERTY LINE	PT	POINT OF TANGENCY
CMP	CORRUGATED METAL PIPE	ROW	RIGHT OF WAY	POT	POINT ON TANGENT
FH	FIRE HYDRANT	FL	FLOW LINE	PCC	POINT OF COMPOUND CURVATURE
CI	CAST IRON	TF	TOP OF FRAME	PRC	POINT OF REVERSE CURVE
DI	DUCTILE IRON	TC	TOP OF CURB OR CONCRETE	VC	VERTICAL CURVE
F-F	FACE-TO-FACE	R	STRUCTURE TO BE RECONSTRUCTED	N&W	NAIL AND WASHER
E-E	EDGE-TO-EDGE	A	STRUCTURE TO BE ADJUSTED	TCE	TEMPORARY CONSTRUCTION EASEMENT
В-В	BACK-TO-BACK		CENTRAL ANGLE	SS	STORM SEWER
ВМ	BENCH MARK	D=	DEGREE OF CURVE	SAN SEW	SANITARY SEWER
INV EL	INVERT ELEVATION	T=	TANGENT LENGTH	PROP	PROPOSED
CL EL	CENTERLINE ELEVATION	L=	CURVE LENGTH	STN STL	STAINLESS STEEL
P	POINT	R=	RADIUS OF CURVE	RJT	RESTRAINED JOINT
G	GUTTER	E=	EXTERNAL DISTANCE	HDD	HORIZONTAL DIRECTIONALLY DRILLED
С	CURB	SE=	SUPERELEVATION (FT. PER FT. OF WIDTH)	LF	LINEAR FEET

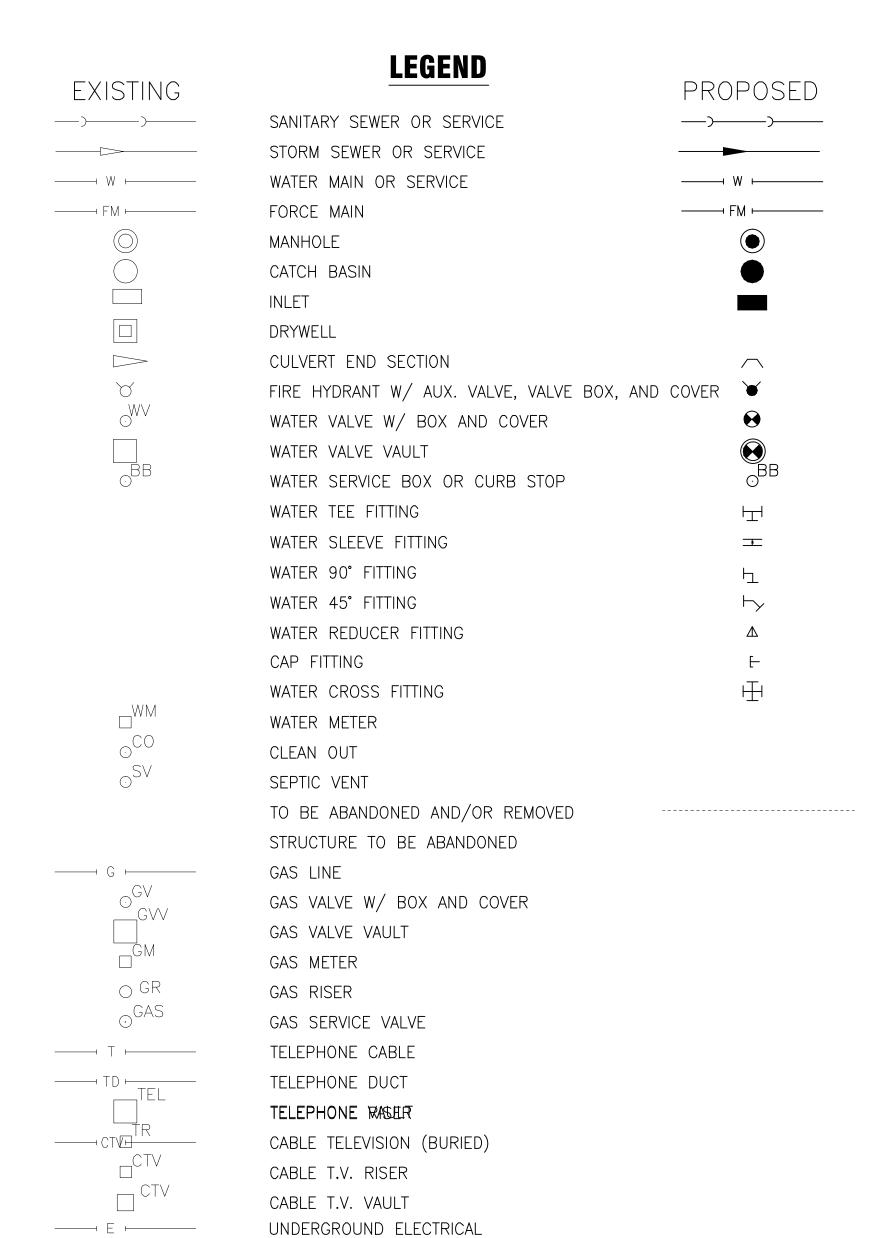BENCHMARKS (NAVD 88 DATUM)

RAILROAD SPIKE SET IN NORTH FACE UTILITY POLE LOCATED

B.M. # 6	•	AT THE SOUTHEAST CORNER OF RICHARDS STREET AND MILLS ROAD. ELEV. = 605.17
B.M. # 7		RAILROAD SPIKE SET IN SOUTH FACE UTILITY POLE LOCATED AT THE NORTHEAST CORNER OF NEAL AVENUE AND MILLS ROAD. ELEV. = 603.44
B.M. # 8	 	RAILROAD SPIKE SET IN SOUTH FACE OF SECOND UTILITY POLE WEST OF THE RAILROAD CROSSING ON MILLS ROAD. ELEV. = 610.15
B.M. # 9	+	RAILROAD SPIKE SET IN SOUTH FACE OF UTILITY POLE LOCATED AT THE NORTHWEST CORNER OF LINNE AVENUE AND MILLS ROAD. ELEV. = 617.34
B.M. # 10	+	RAILROAD SPIKE SET IN SOUTH FACE OF UTILITY POLE LOCATED AT THE NORTHEAST CORNER OF MILLS ROAD AND ROWELL AVENUE. ELEV. = 625.07

TO BID

BAXTER WOODMAN

REVISED -CONSULTANTS REVISED -REVISED -REVISED -

CITY OF JOLIET, ILLINOIS MILLS ROAD WATER MAIN IMPROVEMENTS

LEGENDS, BENCHMARKS, AND ABBREVIATIONS

PROJECT NO:

190223.40

SCALE:

AS NOTED

DESIGNED - ARS DRAWN - TJB/ABN CHECKED - LMS **DATE –** 10–23–19

TOTAL SHEET NO. 18 2

- 2. WHEREVER OBSTRUCTIONS NOT SHOWN ON THE DRAWINGS ARE ENCOUNTERED DURING THE PROGRESS OF THE WORK AND INTERFERE TO SUCH AN EXTENT 'THAT ALTERATIONS TO THE DRAWINGS ARE REQUIRED, THE ENGINEER SHALL BE NOTIFIED PRIOR TO ANY CHANGES.
- 3. HORIZONTAL AND VERTICAL SEPARATION OF WATER MAINS AND SEWER LINES SHALL BE DONE IN ACCORDANCE WITH THE LATEST EDITION OF THE "STANDARD SPECIFICATION FOR WATER AND SEWER CONSTRUCTION IN ILLINOIS".
- 4. PROVIDE 48 HOURS ADVANCE NOTICE TO THE CITY WHEN CONNECTION TO AN EXISTING WATER MAIN WILL BE MADE. COORDINATE SHUTDOWN OF EXISTING WATER MAINS WHEN REQUIRED WITH THE CITY. SCHEDULE THE WORK TO MINIMIZE THE NUMBER AND LENGTH OF SHUTDOWNS. PROVIDE WRITTEN NOTIFICATION OF SHUTDOWNS TO WATER USERS AFFECTED 24 HOURS IN ADVANCE.
- 5. NOTIFY THE CITY'S PUBLIC UTILITIES DEPARTMENT IMMEDIATELY IF EXISTING LEAD WATER SERVICES ARE DISCOVERED.
- 6. PROVIDE PROPERTY OWNERS ADVANCE NOTICE OF CONSTRUCTION ACTIVITIES THAT WILL RESTRICT THE USE OF THEIR DRIVEWAYS.
- 7. DO NOT STORE BEDDING AND BACKFILL MATERIALS, PIPES, FITTINGS, VAULTS, OR OTHER MATERIALS IN AREAS THAT WILL OBSTRUCT SIGHT LINES FOR STREETS AND DRIVEWAYS.
- 8. ALL PROPOSED WATER MAIN AND SERVICES UNDER AND WITHIN 2'OF PAVEMENT OR SIDEWALK SHALL BE BACKFILLED WITH TRENCH BACKFILL WHICH SHALL BE CRUSHED STONE, GRADATION CA 6 OR CA 7.
- 9. INSTALL NEW WATER MAIN WITH A MINIMUM OF 5' COVER BELOW EXISTING OR PROPOSED GROUND SURFACE UNLESS GREATER DEPTH IS REQUIRED TO AVOID EXISTING UTILITIES OR WHERE INDICATED ON THE DRAWINGS.
- 10. PROVIDE COMPRESSION TYPE FIRE HYDRANTS WITH A 5¼-INCH MINIMUM SIZE MAIN VALVE ASSEMBLY, O-RING SEALS, TWO 2½-INCH HOSE NOZZLES, AND A 4½-INCH PUMPER NOZZLE WITH NATIONAL STANDARD THREADS, A NATIONAL STANDARD OPERATING NUT, AND AN ABOVE GROUND BREAK FLANGE. COLOR FOR HYDRANTS ON POTABLE DISTRIBUTION MAINS SHALL BE RED, HYDRANTS ON RAW WATER MAINS SHALL BE GREEN. COLOR FOR PRIVATE SYSTEM HYDRANTS SHALL BE YELLOW. ACCEPTABLE MANUFACTURERS ARE CLOW MEDALLION, EJ 5BR250, OR MUELLER CENTURION A423.
- 11. PROVIDE A TEMPORARY COVERING OVER ALL NEW FIRE HYDRANTS UNTIL ALL NEW WATER MAINS ARE PUT INTO SERVICE AND NEW FIRE HYDRANTS ARE OPERABLE.
- 12. GATE VALVES SHALL BE IN ACCORDANCE WITH AWWA C515 (DUCTILE IRON BODY), BRONZE FITTED, RESILIENT WEDGE AND SEAT TYPE WITH NON-RISING STEM AND O-RING PACKING. ALL INTERNAL AND EXTERNAL SURFACES SHALL HAVE A FUSION BONDED EPOXY COATING. ACCEPTABLE VALVE MANUFACTURERS ARE AMERICAN FLOW CONTROL, CLOW, AND EJ.
- 13. BUTTERFLY VALVES SHALL BE IN ACCORDANCE WITH AWWA C504 FOR PRESSURE CLASS 150B, CAST IRON BODY, RUBBER-SEATED, TIGHT CLOSING TYPE SUITABLE FOR BURIED SERVICE. ACCEPTABLE VALVE MANUFACTURERS ARE AMERICAN FLOW CONTROL, CLOW, AND EJ.
- 14. LOCATE PRESSURE CONNECTIONS, IF INDICATED ON THE DRAWINGS OR WHEN DIRECTED BY THE ENGINEER, A MINIMUM OF 2' FROM ANY EXISTING REPAIR SLEEVES OR PIPE JOINTS.
- 15. THE CITY OF JOLIET WATER DEPARTMENT SHALL BE RESPONSIBLE FOR COMPLETING ALL TAPS TO EXISTING WATER MAINS. CONTRACTOR WILL BE RESPONSIBLE FOR CALLING 815-724-4230 TO SCHEDULE AN APPOINTMENT WITH THE CITY WATER DEPARTMENT. APPOINTMENTS ARE AVAILABLE ON TUESDAYS AND THURSDAYS.
- 16. SUCCESSFULLY TEST, DISINFECT, AND FLUSH WATER MAIN, AND OBTAIN ACCEPTANCE OF THE WATER MAIN BY THE CITY OF JOLIET, PRIOR TO MAKING WATER SERVICE CONNECTIONS. FLUSH PIPELINES TO OBTAIN A VELOCITY OF 2.5 FT/S PER AWWA STANDARD C651.
- 17. USE MECHANICAL JOINT FITTINGS TO PLUG/CAP EXISTING WATER MAINS TO REMAIN IN SERVICE AND FOR EXISTING WATER MAINS TO BE ABANDONED. PLUGS/CAPS ON WATER MAIN TO REMAIN IN SERVICE SHALL INCLUDE AN ADEQUATELY SIZED CAST-IN-PLACE CONCRETE THRUST BLOCK.
- 18. AS-BUILT DRAWINGS SHALL BE PREPARED BY THE CONTRACTOR AND SUBMITTED TO THE ENGINEER AS SOON AS THE PROJECT IS COMPLETED. ANY CHANGE IN THE LENGTH, LOCATION, OR ALIGNMENT SHALL BE SHOWN IN RED.
- 19. EROSION CONTROL WILL BE CONSTRUCTED IN ACCORDANCE WITH STANDARD SPECIFICATIONS FOR SOIL EROSION AND SEDIMENT CONTROL AS CONTAINED IN IEPA/WPC/87-012 OR CURRENT EDITION.
- 20. REPLACE ALL CONCRETE SIDEWALKS DISTURBED BY CONSTRUCTION TO THE NEAREST CONSTRUCTION JOINT. A MAXIMUM LENGTH OF TEN LINEAL FEET PER CROSSING WILL BE UTILIZED FOR PAY QUANTITY CALCULATIONS.
- 21. PAVEMENT RESTORATION WILL BE MEASURED IN PLACE AND THE AREA COMPUTED IN SQUARE YARDS. ALL AREAS DISTURBED WILL BE REPLACED, BUT THE MAXIMUM ALLOWABLE WIDTHS USED FOR PAY QUANTITY CALCULATIONS WILL BE 6 FEET CENTERED ON THE PIPE. IF THE CONTRACTOR RELOCATES THE TRENCH AWAY FROM THE CURB AND GUTTER, THE PAVEMENT PATCH WILL EXTEND FROM THE SAWCUT IN THE EXISTING PAVEMENT TO THE FACE OF THE GUTTER AND THE MAXIMUM ALLOWABLE WIDTH OF 6 FEET WILL BE USED FOR PAY QUANTITY CALCULATIONS.
- MILLS ROAD SHALL HAVE 10 INCHES OF BINDER AND 2 INCHES OF SURFACE COURSE.
- RICHARDS STREET SHALL HAVE 10 BINDER AND 2 INCHES OF SURFACE COURSE.
- 22. IT SHALL BE THE CONTRACTOR'S DUTY AND RESPONSIBILITY TO ASCERTAIN AND EXECUTE THE MEANS, METHODS, AND SEQUENCE OF CONSTRUCTION IN ACCORDANCE WITH THE DRAWINGS, SPECIFICATIONS, AND OTHER CONTRACT DOCUMENTS. THIS SHALL INCLUDE, BUT SHALL NOT BE LIMITED TO, THE EXCLUSIVE DUTY AND RESPONSIBILITY TO PROVIDE FOR WORKPLACE SAFETY AND WORKER SUPERVISION. IT SHALL EXCLUSIVELY BE THE CONTRACTOR'S DUTY AND RESPONSIBILITY TO INVESTIGATE AND ASCERTAIN THE CURRENT PHYSICAL STATE AND OPERATIONAL STATUS OF THE CITY'S WATER SUPPLY SYSTEM AND THE CITY'S SANITARY SEWER SYSTEM, INCLUDING WHETHER A WATER MAIN OR OTHER VESSEL IS OPERATIONAL, CONTAINS WATER, IS PRESSURIZED, OR IS OTHERWISE SAFE TO ALTER. ANY INFORMATION PROVIDED BY THE CITY, OR ITS EMPLOYEES AND CONSULTANTS, REGARDING THE STATE OF ITS WATER SUPPLY AND SANITARY SEWER SYSTEMS IS PROVIDED AS A COURTESY TO THE CONTRACTOR BUT IS NOT WARRANTED TO BE TRUE AND MAY NOT BE RELIED ON BY THE CONTRACTOR IN SATISFACTION OF, OR TO DIMINISH, ITS EXCLUSIVE DUTY TO ASCERTAIN AND EXECUTE THE MEANS, METHODS, AND SEQUENCES OF CONSTRUCTION IN ACCORDANCE WITH THE DRAWINGS, SPECIFICATIONS, AND OTHER CONTRACT DOCUMENTS AND ITS EXCLUSIVE RESPONSIBILITY TO PROVIDE FOR WORKPLACE SAFETY AND WORKER SUPERVISION.
- 23. WATER SERVICE INSTALLATION WORK MUST BEGIN WITHIN 7 DAYS OF IEPA APPROVAL. FINAL PAVEMENT RESTORATION MUST BE COMPLETED WITHIN 21 DAYS AFTER THE LAST COMPLETED WATER SERVICE CONNECTION ON ANY ONE STREET OR MOVING THE EXCAVATION CREW AND EQUIPMENT TO ANOTHER STREET. THE CONTRACTOR HAS THE OPTION TO INSTALL TEMPORARY PAVEMENT AT NO ADDITIONAL COST TO THE CITY WITHIN 7 CALENDAR DAYS. THE CITY CAN STOP OPERATIONS UNTIL TEMPORARY PAVEMENT IS PLACED OR PERMANENT PAVEMENT RESTORATION IS COMPLETE.

TRAFFIC CONTROL NOTES

- 1. MILLS RD HAS A POSTED SPEED LIMIT OF 30 MPH.
- 2. RICHARDS ST HAS A POSTED SPEED LIMIT OF 35 MPH.
- 3. ALL CONFLICTING PAVEMENT MARKINGS, INCLUDING SKIP DASHES WITHIN LANE CLOSURE TAPERS, SHALL BE COVERED WITH BLACKOUT TAPE.
- 4. THE CONTRACTOR SHALL SUBMIT IDOT FORM BSPE-725 FOR LANE CLOSURES ALONG RICHARDS ST.
- 5. MAINTAIN TEMPORARY ACCESS TO ALL HOMES AND BUSINESSES UNLESS SPECIFICALLY NOTED.
- 6. UTILIZE FLAGGERS ON NEAL AVE AND TEMPORARY PAVEMENT WITHIN INTERSECTION TO MAINTAIN ACCESS. NEAL AVE TO REMAIN OPEN DURING CONSTRUCTION.
- 7. ALL TRENCHES AND HOLES SHALL BE FILLED OR COVERED WITH STEEL PLATES AT THE END OF EACH DAY. ALL LANES SHALL BE OPEN AT THE END OF EACH WORK DAY. THIS WORK SHALL BE INCLUDED IN THE COST OF TRAFFIC CONTROL
- 8. SEE HIGHWAY STANDARDS FOR ADDITIONAL DETAILS AND REQUIREMENTS NOT SHOWN ON MOT PLANS.
- 9. SERVICE CONNECTIONS AND FIRE HYDRANT LEADERS THAT ARE NOT INSTALLED TRENCHLESS SHALL BE STAGED SUCH THAT ONLY ONE LANE MAY BE CLOSED AT ANY TIME IN ACCORDANCE WITH HIGHWAY STANDARDS 701501. CLOSURES FOR SERVICE OPERATIONS SHALL BE DAYTIME ONLY.
- 10. EMERGENCY VEHICLE ACCESS SHALL BE MAINTAINED AT ALL TIMES. ANY CHANGE IN TRAFFIC CONTROL SHALL HAVE PRIOR APPROVAL BY THE ENGINEER. THE CONTRACTOR SHALL PROVIDE A MINIMUM OF THREE (3) DAYS NOTICE IN ADVANCE OF CONSTRUCTION ACTIVITIES.
- 11. THE CONTRACTOR SHALL SUBMIT A PREPLANNED SEQUENCE OF WORK PRIOR TO THE START OF WORK FOR REVIEW AND APPROVAL. NO WORK SHALL COMMENCE UNTIL THE PREPLANNED SEQUENCE OF WORK HAS BEEN APPROVED BY THE CITY. WORK SHALL BE SCHEDULED TO MINIMIZE INCONVENIENCE TO PROPERTY OWNERS AND TENANTS AND TO MAINTAIN A REASONABLE LEVEL OF CONSTRUCTION EFFICIENCY. THE CITY AND/OR ENGINEER RESERVES THE RIGHT TO RESTRICT WORK ON ANY SEGMENT IF CONSTRUCTION OPERATIONS ON A PREVIOUS SEGMENT ARE UNACCEPTABLE; TRAFFIC CONTROL OPERATIONS BECOME UNACCEPTABLE; OR AN EROSION CONTROL DEFICIENCY EXISTS.
- 12. THE CONTRACTOR SHALL MAINTAIN 2-WAY TRAFFIC ON ALL SIDE STREETS AND ON MILLS RD AND RICHARDS ST UNLESS OTHERWISE SHOWN.
- 13. THE COST OF ADDITIONAL DEPLOYMENTS, SETUPS AND/OR MOBILIZATIONS NEEDED FOR STAGED CONSTRUCTION SHALL BE INCLUDED IN THE COST OF TRAFFIC CONTROL AND PROTECTION AND NO ADDITIONAL COMPENSATION WILL BE ALLOWED.
- 14. THE CONTRACTOR WILL BE REQUIRED TO ATTEND WEEKLY PROGRESS MEETINGS WITH THE CITY AND ENGINEER TO PROVIDE WEEKLY UPDATES ON THE PROPOSED WORK SCHEDULE AND UPCOMING SEQUENCE OF CONSTRUCTION ACTIVITIES. THE WORK SCHEDULE AND SEQUENCE OF WORK WILL REQUIRE APPROVAL OF THE CITY AND COORDINATION WITH IMPACTED PROPERTY OWNERS AND TENANTS.
- 15. ALL FLAGGERS REQUIRED FOR MAINTENANCE OF TRAFFIC, INCLUDING ANY FLAGGERS NEEDED TO MAINTAIN TRAFFIC FOR SIDE STREETS AND COMMERCIAL DRIVEWAYS, SHALL BE INCLUDED IN THE COST OF TRAFFIC CONTROL AND PROTECTION.
- 16. AGGREGATE SURFACE WILL NOT BE ALLOWED FOR MAINTAINING MAINLINE TRAFFIC. PATCHING OPERATIONS SHALL BE STAGED SO THAT PATCHING AND/OR TEMPORARY PAVEMENT CAN BE COMPLETED ON THE SAME DAY AS PAVEMENT REMOVAL.
- 17. THE CONTRACTOR SHALL PROVIDE TEMPORARY ACCESS TO DRIVEWAYS AND SIDE STREETS DURING CONSTRUCTION USING CRUSHED STONE OR CRUSHED AGGREGATE. THIS WORK SHALL BE INCLUDED IN THE COST OF TRAFFIC CONTROL AND PROTECTION.
- 18. ALL COMMERCIAL PROPERTIES AND PARKING LOTS SHALL BE PROVIDED AT LEAST ONE INGRESS AND ONE EGRESS AT ALL TIMES. THE CONTRACTOR SHALL COORDINATE DRIVEWAY CLOSURES WITH THE PROPERTY OWNERS AND TENANTS AND THE ENGINEER. IF NECESSARY, THE CONTRACTOR SHALL MAINTAIN ACCESS TO COMMERCIAL DRIVEWAYS BY USE OF FLAGGERS DURING CONSTRUCTION WORK HOURS AS DETERMINED BY THE ENGINEER.
- 19. RESIDENTS AND BUSINESSES SHALL HAVE ACCESS TO THEIR DRIVEWAYS AT THE END OF EACH DAY. EXCEPT DURING ADJACENT CURB AND GUTTER REPLACEMENT OR CONCRETE DRIVEWAY REPLACEMENT.
- 20. ALL TYPE I OR II BARRICADES, DRUMS, AND VERTICAL PANELS SHALL BE EQUIPPED WITH STEADY BURN MONO-DIRECTIONAL LIGHTS. UNLESS OTHERWISE NOTED ON THE PLANS, SPACING SHALL BE AT 50 FOOT INTERVALS IN TANGENTS, 20 FOOT INTERVALS IN TAPERS, AND 10 FOOT INTERVALS IN RADII AND CURVES OR AS DETERMINED BY THE
- 21. THE CONTRACTOR SHALL LIMIT THE NUMBER OF WATER MAIN SHUTDOWNS.
- 22. ALL SAW CUTS REQUIRED FOR PATCHING AND REMOVAL ITEMS, INCLUDING PARTIAL REMOVAL NECESSARY FOR STAGE CONSTRUCTION, SHALL NOT BE PAID FOR SEPARATELY, BUT SHALL BE INCLUDED IN THE COST OF THE PATCHING OR REMOVAL ITEM.
- 23. DRIVEWAY ENTRANCE SIGNS SHALL BE INSTALLED IN ACCORDANCE WITH THE DETAIL FOR DRIVEWAY ENTRANCE SIGNING AT ALL COMMERCIAL DRIVEWAYS ADJACENT TO TRAFFIC CONTROL OPERATIONS. RELOCATIONS OF THESE SIGNS SHALL BE COMPLETED AS NEEDED FOR EACH STAGE. THESE SIGNS SHALL BE INCLUDED IN THE COST OF TRAFFIC CONTROL AND

SUMMARY OF QUANTITIES

	City of Joliet		
	Mills Road Water Main Improvements		
No.	PAY ITEM	UNIT	QUANTII
	PRECONCERNICATION VIREO PECOPRINO	10104	1
1	PRECONSTRUCTION VIDEO RECORDING	LSUM	1
2	TRAFFIC CONTROL AND PROTECTION	LSUM	1 700
3	TRENCH BACKFILL	CUYD	326
4	CURED-IN-PLACE-PIPE (WATER MAIN REHABILITATION), 12INCH	FOOT	2,372
5	DUCTILE IRON WATER MAIN, 6—INCH RJT	FOOT	75
6	DUCTILE IRON WATER MAIN, 8-INCH RJT	FOOT	24
7	DUCTILE IRON WATER MAIN, 12—INCH RJT	FOOT	291
8	MISCELLANEOUS FITTINGS	POUND	2,000
9	WATER SERVICE CONNECTION TO WATER MAIN	EACH	28
10	WATER SERVICE LINE TYPE K — OPEN CUT, 1—INCH	FOOT	93
11	WATER SERVICE LINE TYPE K — DIRECTIONAL DRILLING, 1—INCH	FOOT	233
12	WATER SERVICE LINE TYPE K — OPEN CUT, 1.5—INCH	FOOT	93
13	WATER SERVICE LINE TYPE K — DIRECTIONAL DRILLING, 1.5—INCH	FOOT	233
14	WATER SERVICE LINE TYPE K - OPEN CUT, 2-INCH	FOOT	101
15	WATER SERVICE LINE TYPE K - DIRECTIONAL DRILLING, 2-INCH	FOOT	233
16	WATER SERVICE LINE TYPE K - OPEN CUT, 3-INCH	FOOT	25
17	PROJECT MANAGEMENT	HOUR	10
18	WATER SERVICE CONNECTION ON PRIVATE PROPERTY - BASEMENT OR CRAWL SPACE	EACH	1
19	WATER SERVICE CONNECTION ON PRIVATE PROPERTY - SLAB	EACH	1
20	WATER SERVICE LINE TYPE L, 1-INCH	FOOT	10
21	WATER SERVICE LINE TYPE L, 1.5-INCH	FOOT	10
22	UTILITY LOCATION - PRIVATE PROPERTY	EACH	10
23	WATER METER RELOCATION	EACH	10
24	CONNECT TO WATER MAIN (NON-PRESSURE), 6-INCH	EACH	2
25	CONNECT TO WATER MAIN (NON-PRESSURE), 8-INCH	EACH	2
26	CONNECT TO WATER MAIN (NON-PRESSURE), 12-INCH	EACH	3
27	GATE VALVE, 6-INCH	EACH	2
28	GATE VALVE, 8-INCH	EACH	2
29	GATE VALVE, 12-INCH	EACH	9
30	VALVE BOX	EACH	4
31	VALVE VAULT, 5-FOOT DIAMETER	EACH	9
32	FIRE HYDRANT	EACH	6
33	LINE STOP, 6-INCH	EACH	1
34	LINE STOP, 8-INCH	EACH	1
35	LINE STOP, 12-INCH	EACH	1
36	FIRE HYDRANT TO BE REMOVED	EACH	5
37	VALVE VAULT TO BE REMOVED	EACH	5
	VALVE BOX TO BE REMOVED	EACH	4
39	INLET PROTECTION FILTER	EACH	10
40	HOT-MIX ASPHALT REMOVAL AND REPLACEMENT, 10" BINDER & 2" SURFACE	SQYD	210
41	TEMPORARY HOT-MIX ASPHALT, 2 INCH	SQYD	100
42	GRAVEL SHOULDER RESTORATION	SQYD	96
43	CLASS D PATCH	SQYD	100
44	PCC DRIVEWAY REMOVAL AND REPLACEMENT	SQYD	120
45	CONCRETE CURB AND GUTTER REMOVAL AND REPLACEMENT	FOOT	66
 46	DETECTABLE WARNINGS	SQFT	40
47	PAVEMENT MARKINGS	FOOT	40
48	RESTORATION OF LAWNS AND PARKWAYS	SQYD	720
49	CLEARING	LSUM	1
49 50	REMOVAL AND REPLACEMENT OF UNSUITABLE MATERIAL	CUYD	7
50 51		CUYD	20
	CONTAMINATED WASTE DISPOSAL		
52	SOIL TESTS FOR CONTAMINANTS	EACH	20
53	EXPLORATORY EXCAVATION	EACH	1
54	WARRANTY PERIOD LEAK DETECTION	LSUM	1
55	ADDITIONAL ACCESS PIT	EACH	1
56	TEMPORARY WATER SYSTEM	LSUM	1 5 000
57	WATER USAGE	HCF	5,000

TO BID

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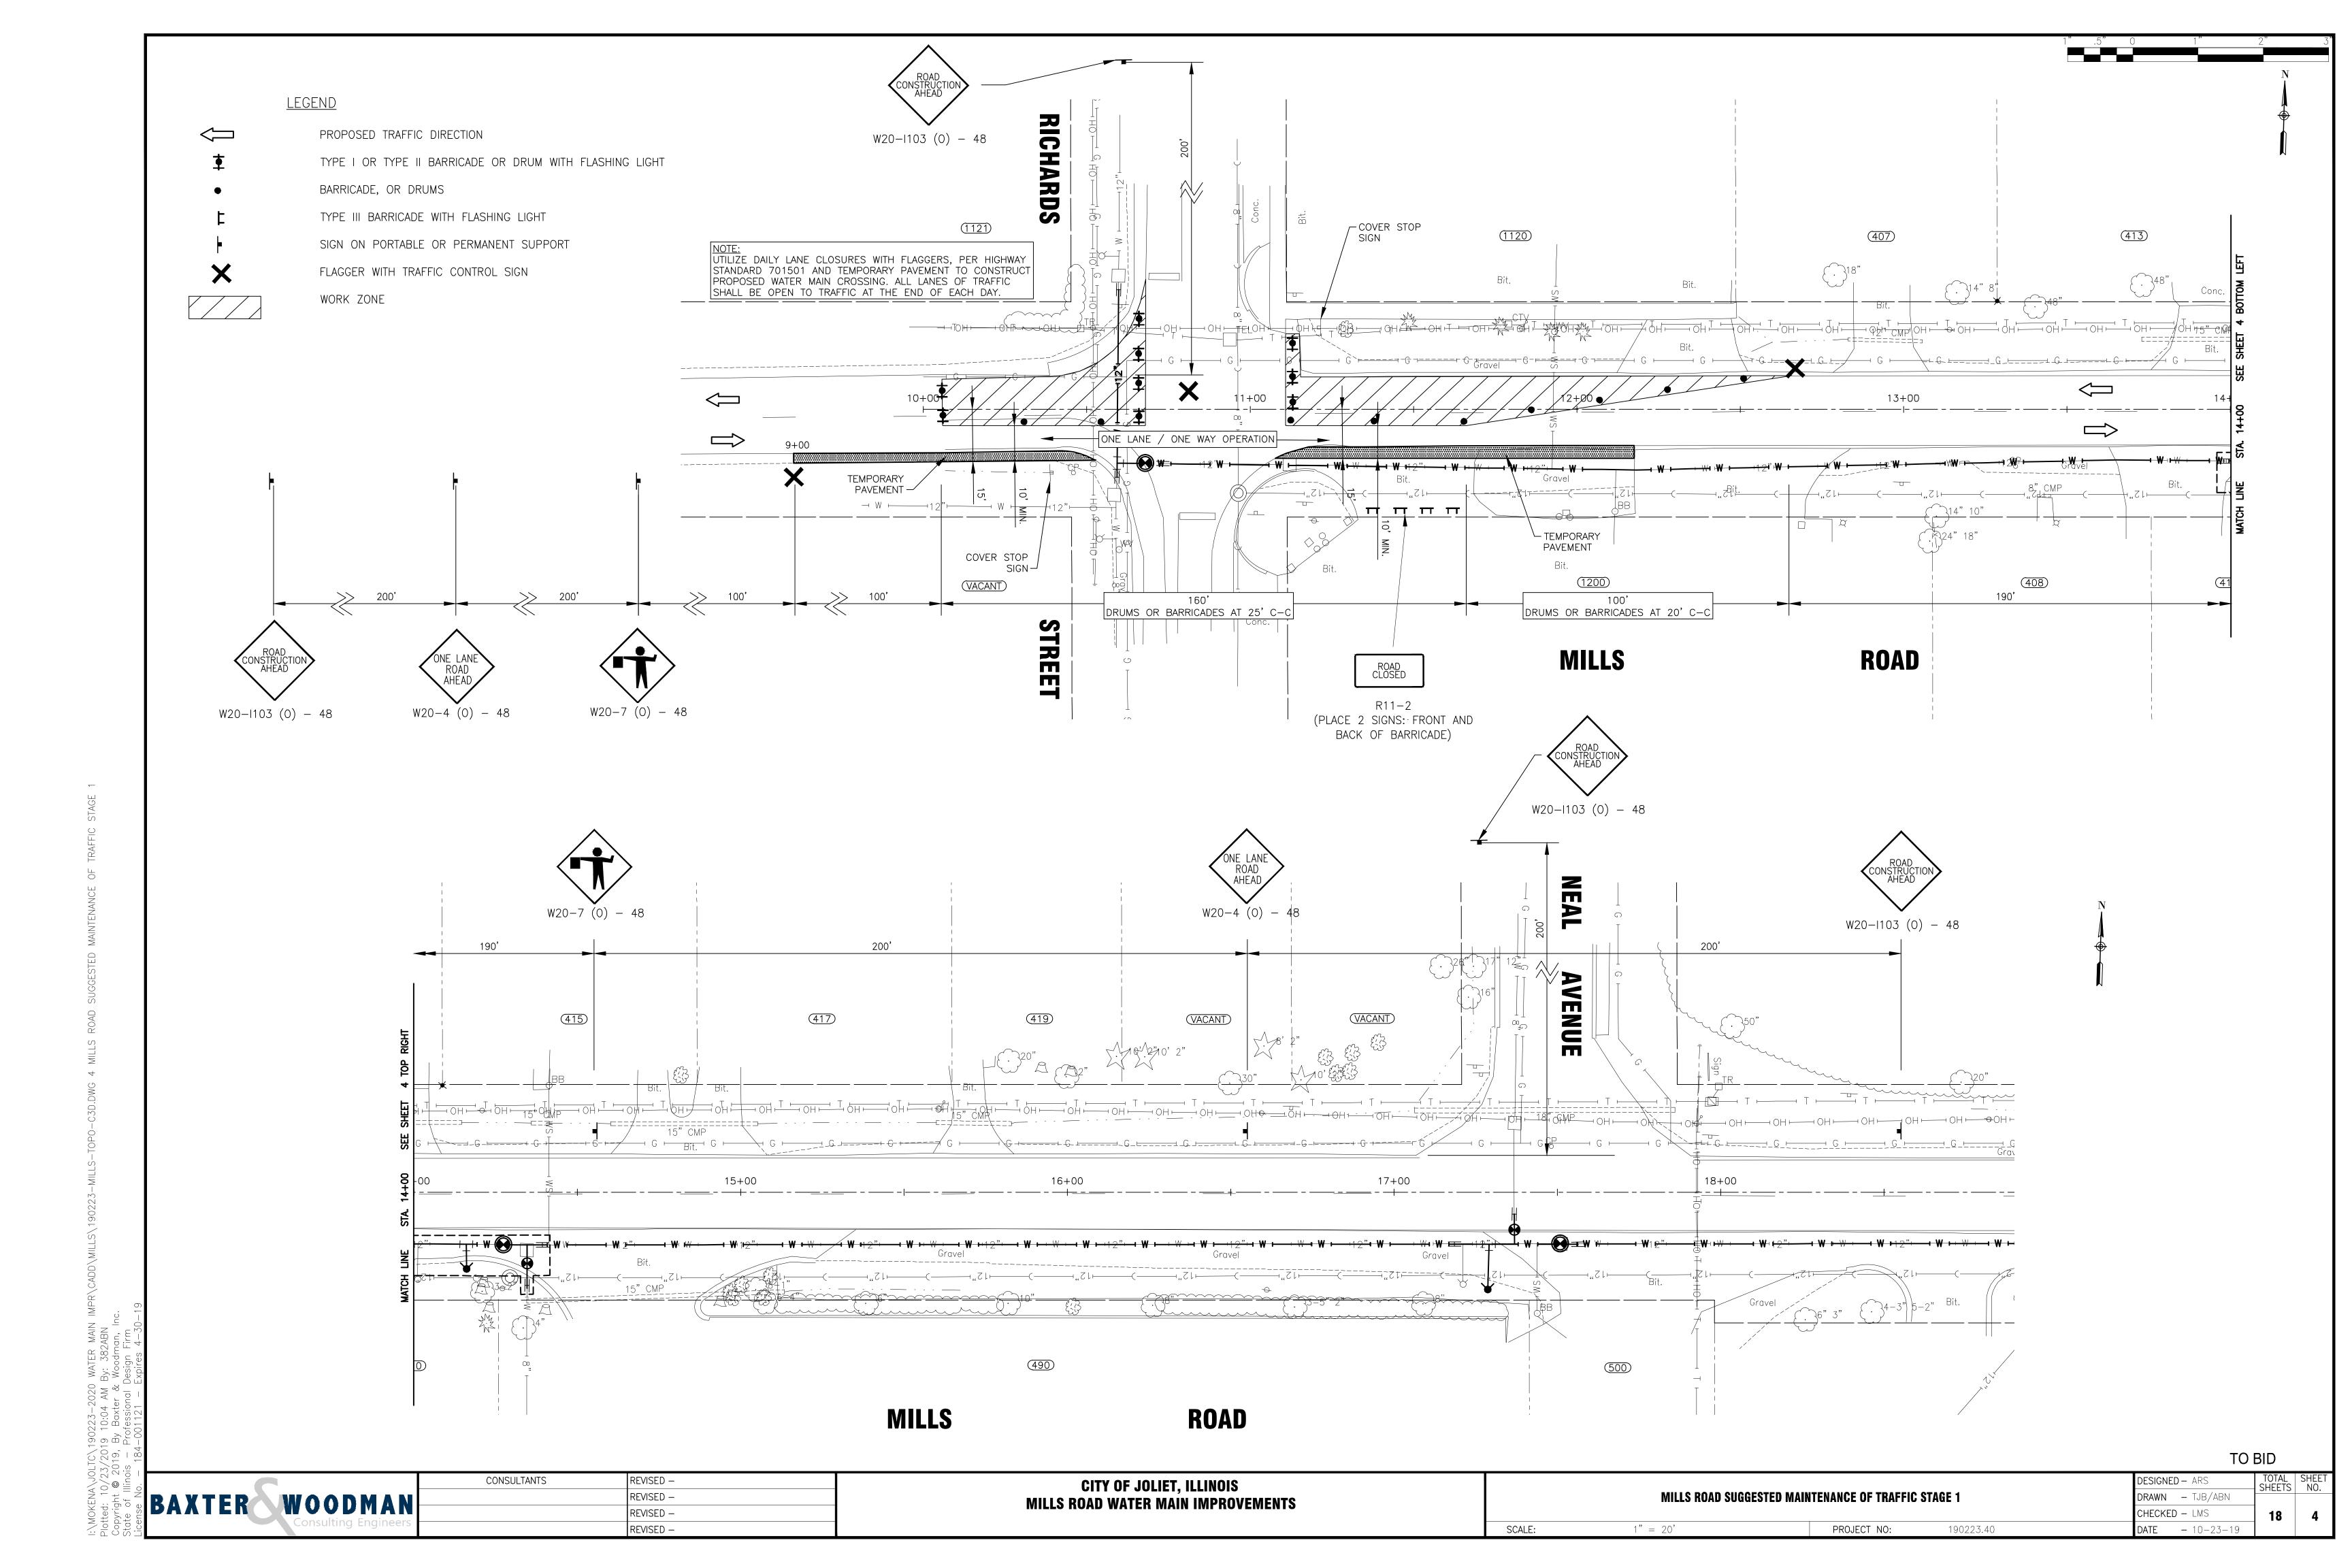
CITY OF JOLIET, ILLINOIS MILLS ROAD WATER MAIN IMPROVEMENTS


GENERAL NOTES, AND SUMMARY OF QUANTITIES

SCALE:

DESIGNED — ARS DRAWN — TJB/ABN CHECKED - LMS 18 3 **DATE** - 10-23-19

AS NOTED PROJECT NO: 190223.40



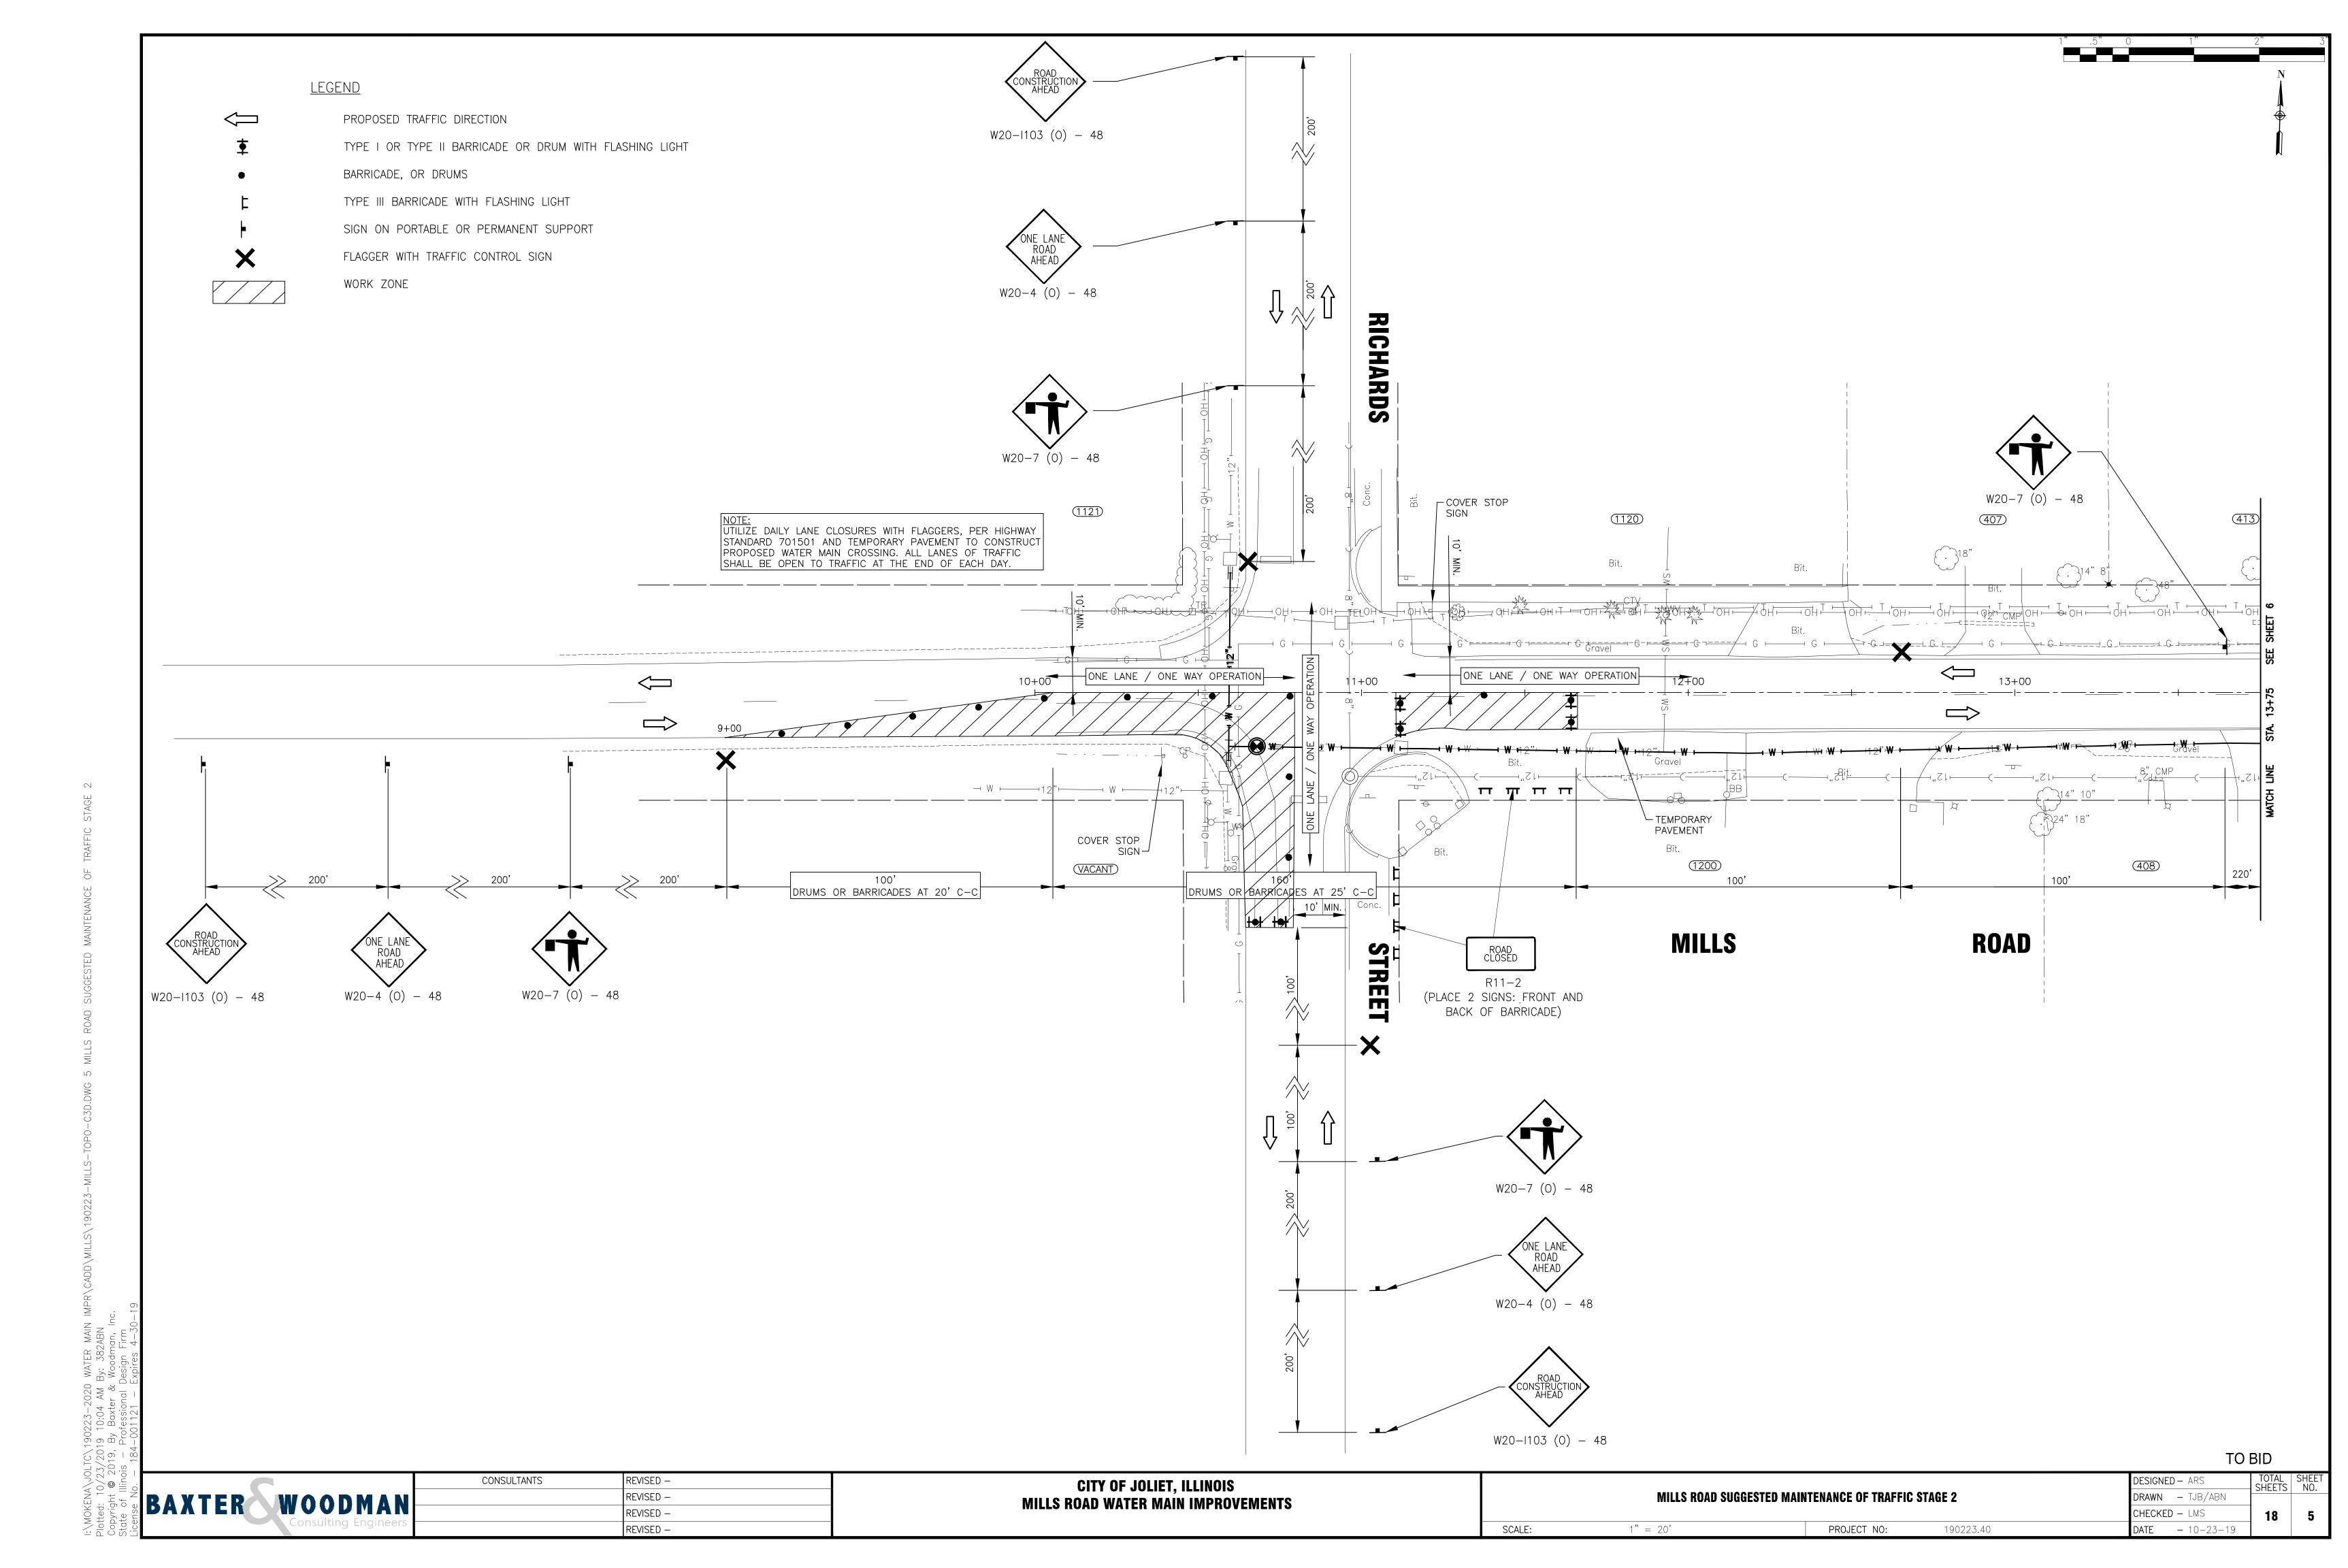

TYPE I OR TYPE II BARRICADE OR DRUM WITH FLASHING LIGHT


SIGN ON PORTABLE OR PERMANENT SUPPORT

BARRICADE, OR DRUMS

TYPE III BARRICADE WITH FLASHING LIGHT

FLAGGER WITH TRAFFIC CONTROL SIGN

WORK ZONE

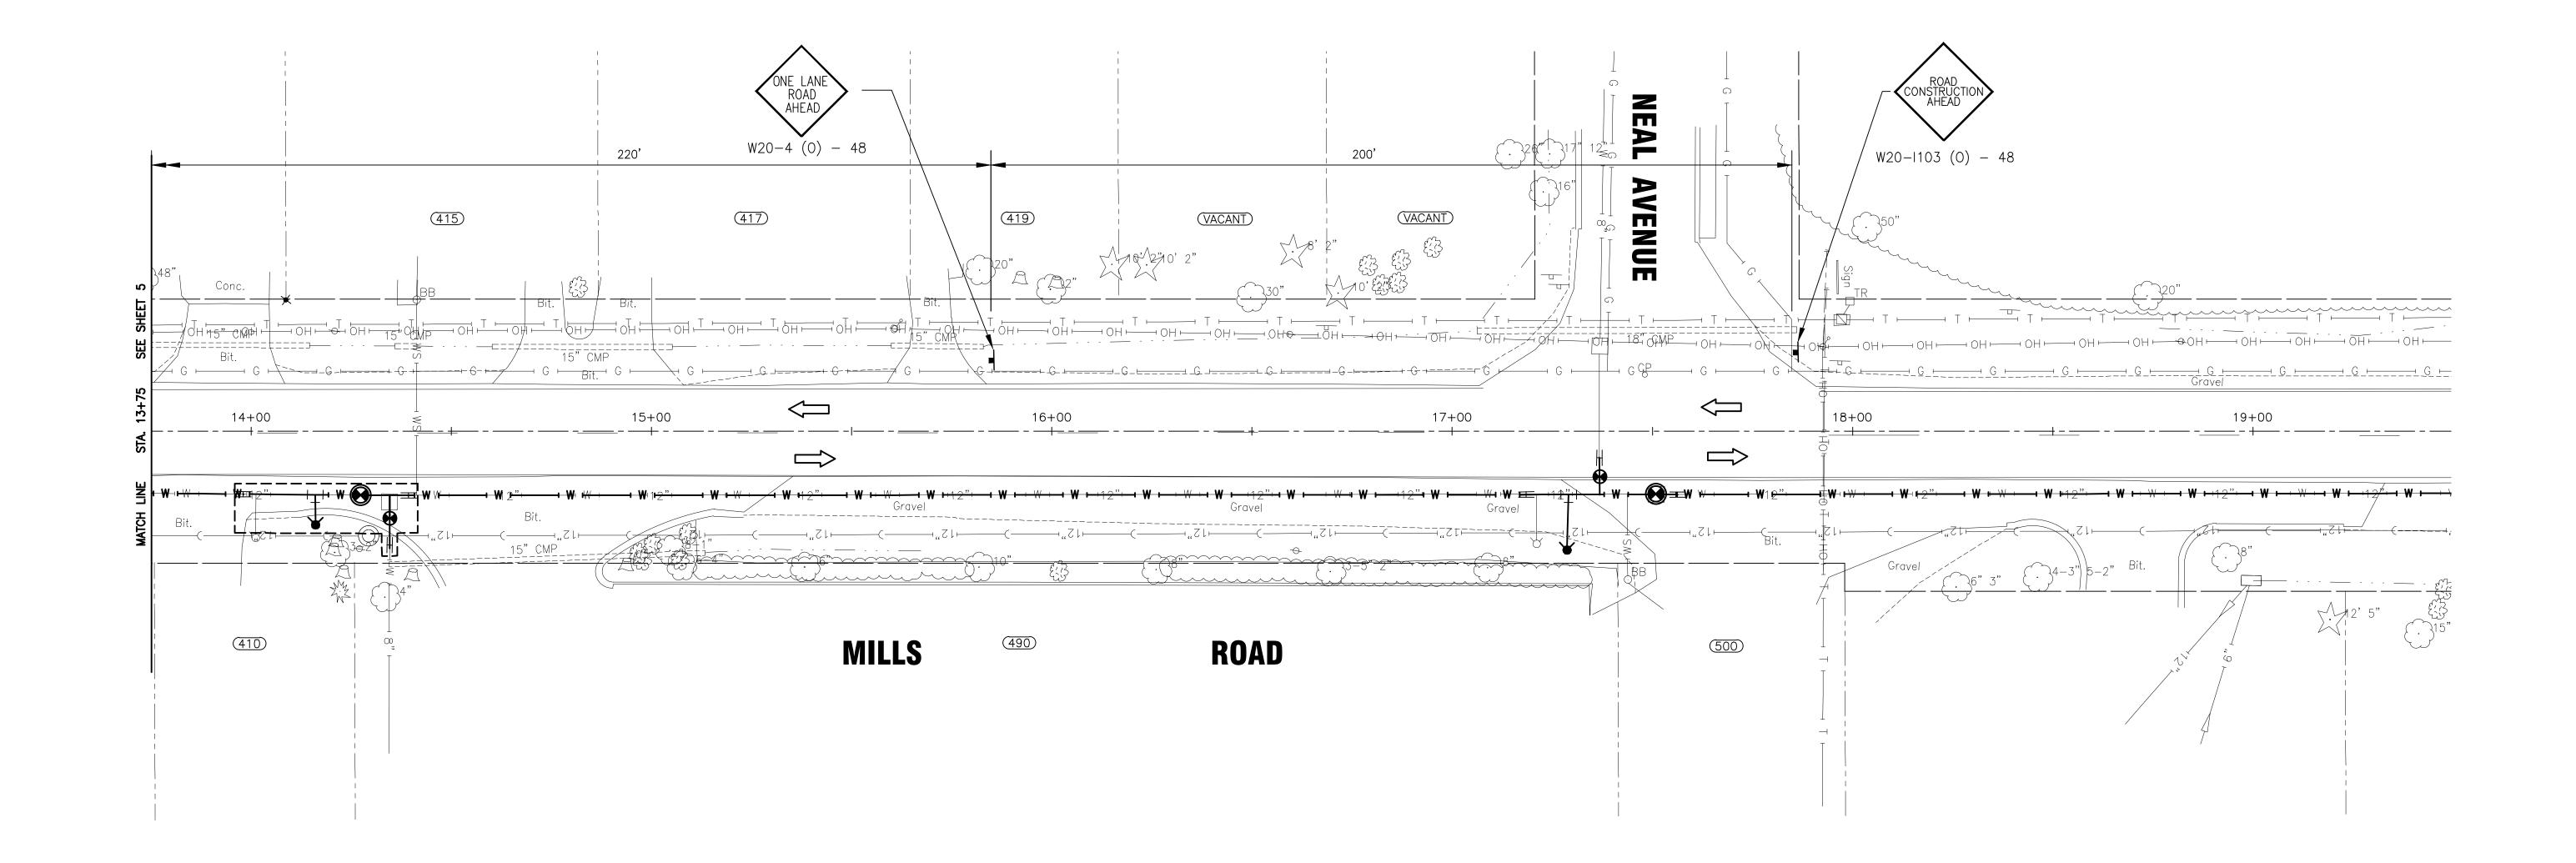

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CITY OF JOLIET, ILLINOIS MILLS ROAD WATER MAIN IMPROVEMENTS

MILLS ROAD SUGGESTED MAINTENANCE OF TRAFFIC STAGE 2

PROJECT NO:


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1" = 20'

SCALE:

DESIGNED - ARS DRAWN - TJB/ABN CHECKED - LMS **DATE –** 10–23–19

TOTAL SHEET NO. 18 6

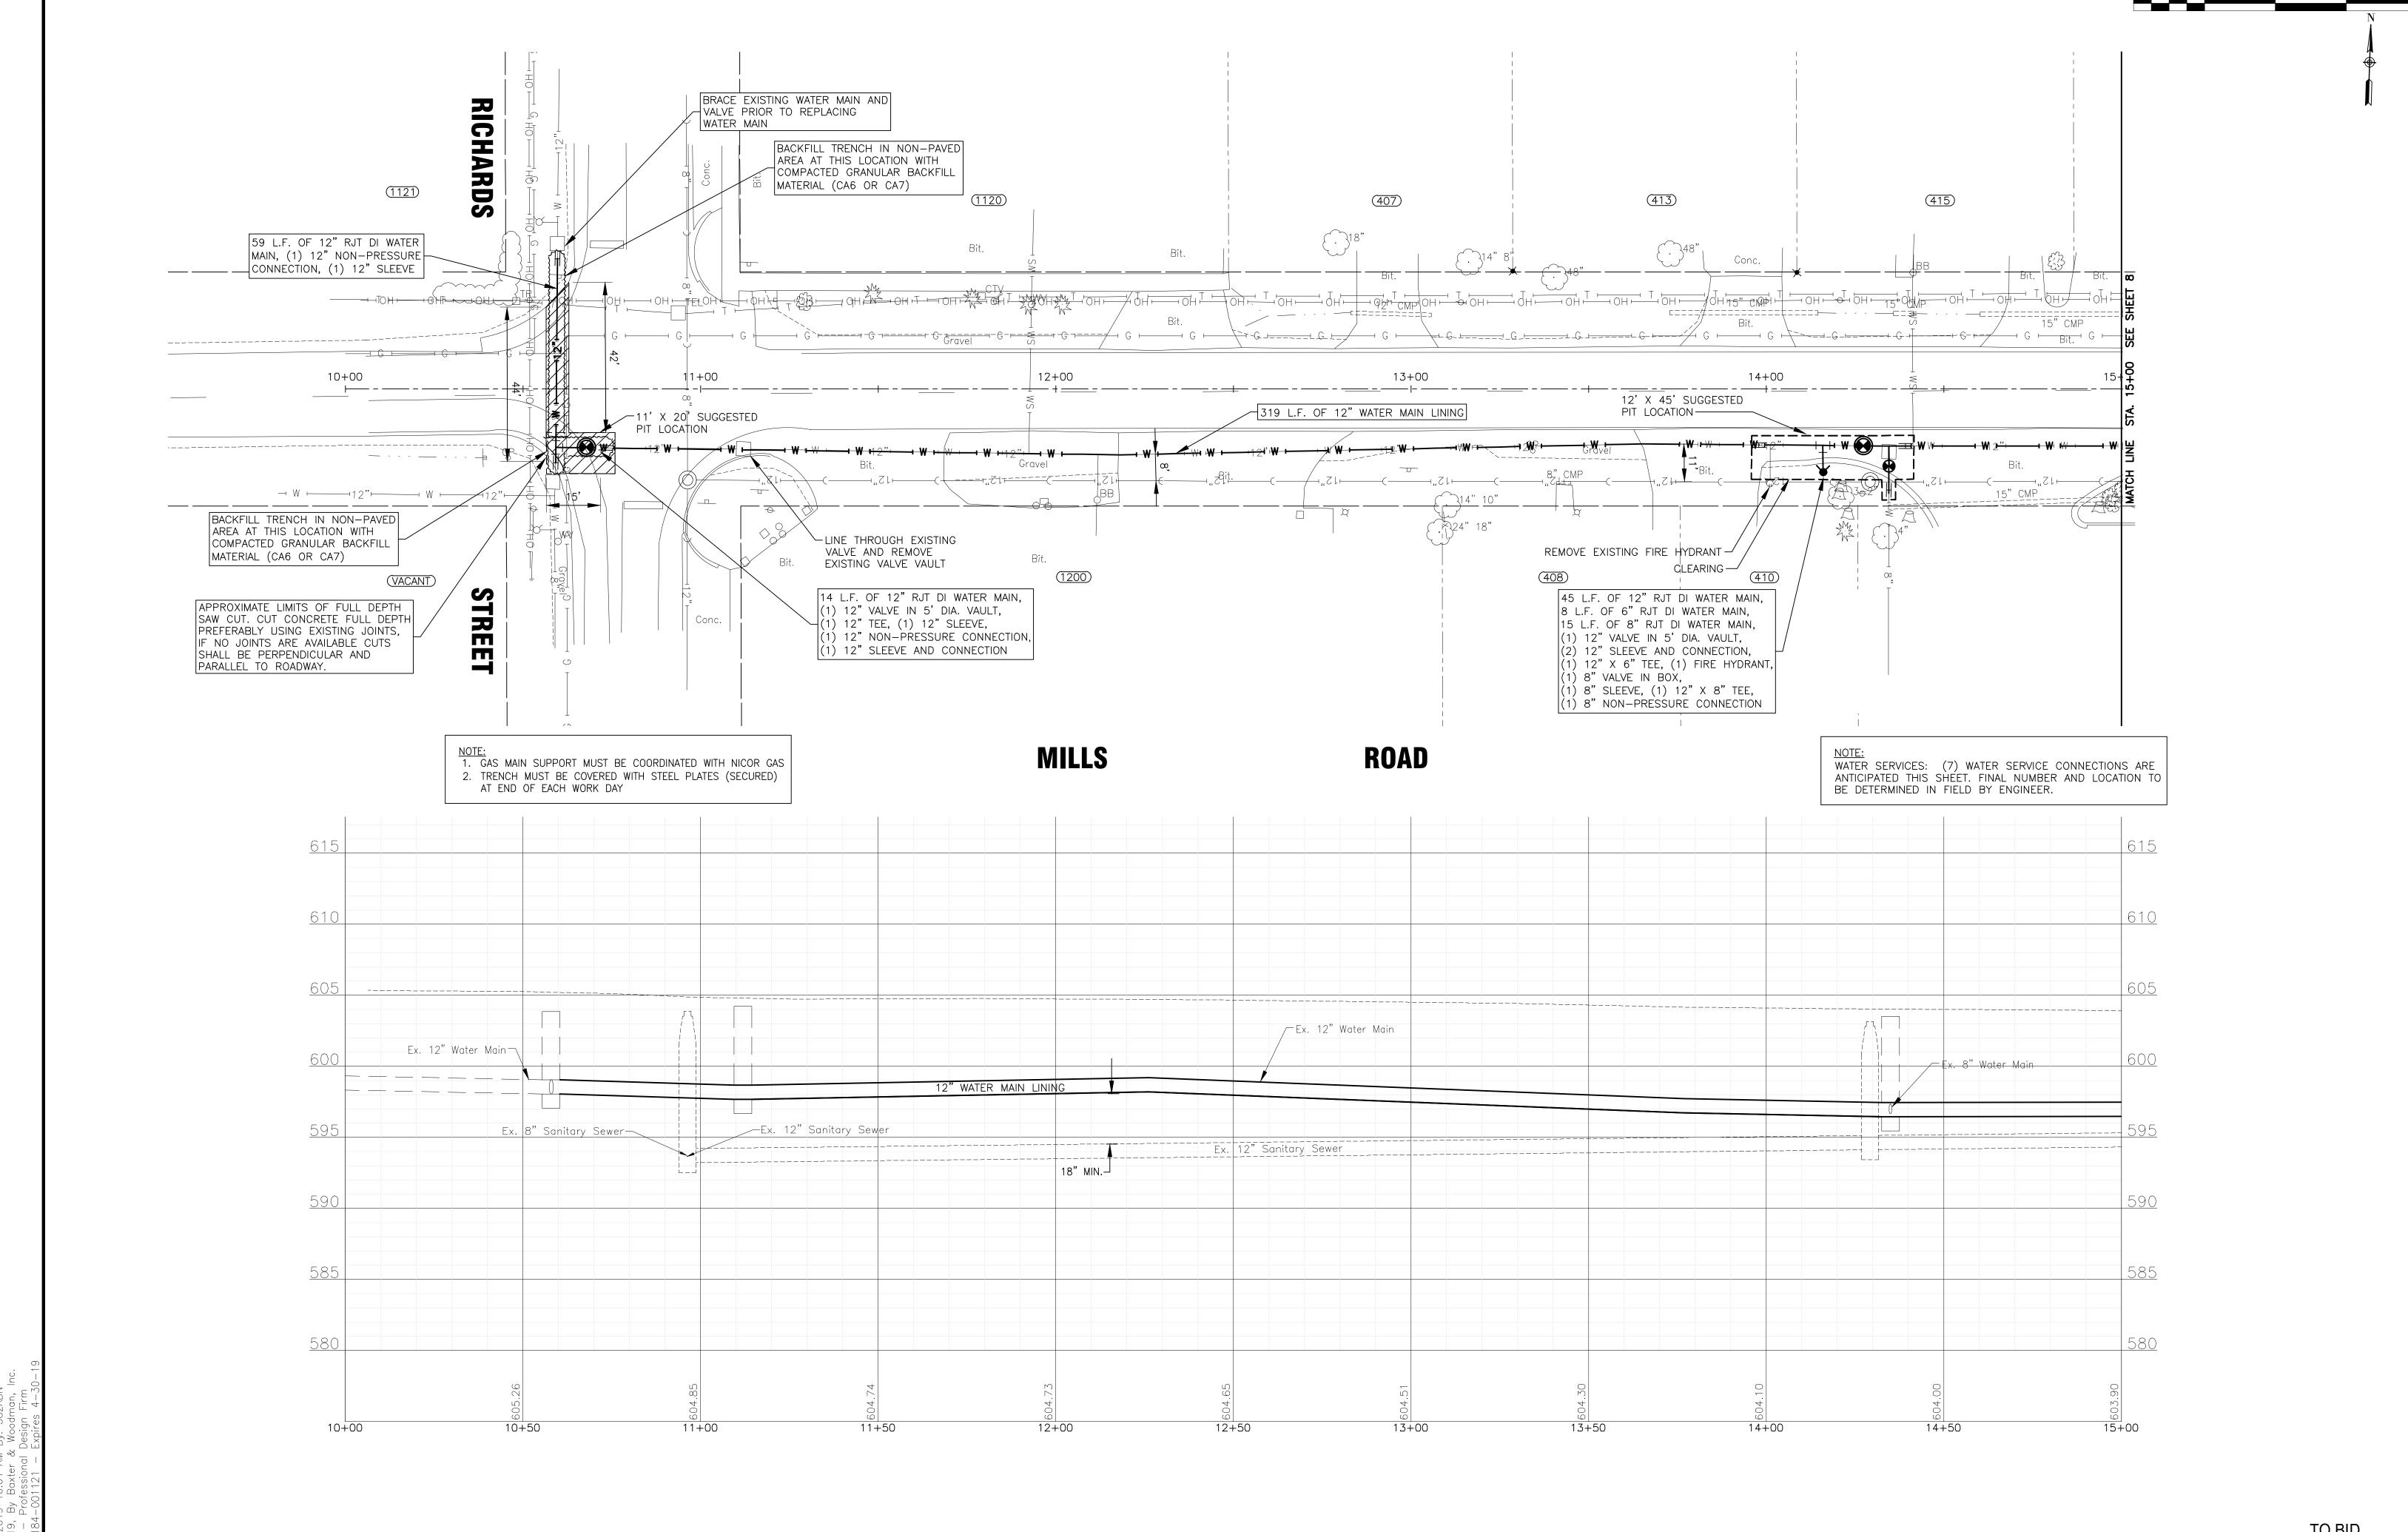

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CONSULTANTS BAXTER WOODMAN

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CITY OF JOLIET, ILLINOIS MILLS ROAD WATER MAIN IMPROVEMENTS

MILLS ROAD STA. 10+00 TO STA. 15+00 PLAN AND PROFILE


PROJECT NO:

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SCALE:

HORIZ 1"=20' / VERT 1"=5'

DESIGNED - ARS DRAWN — TJB/ABN CHECKED - LMS **DATE** - 10-23-19

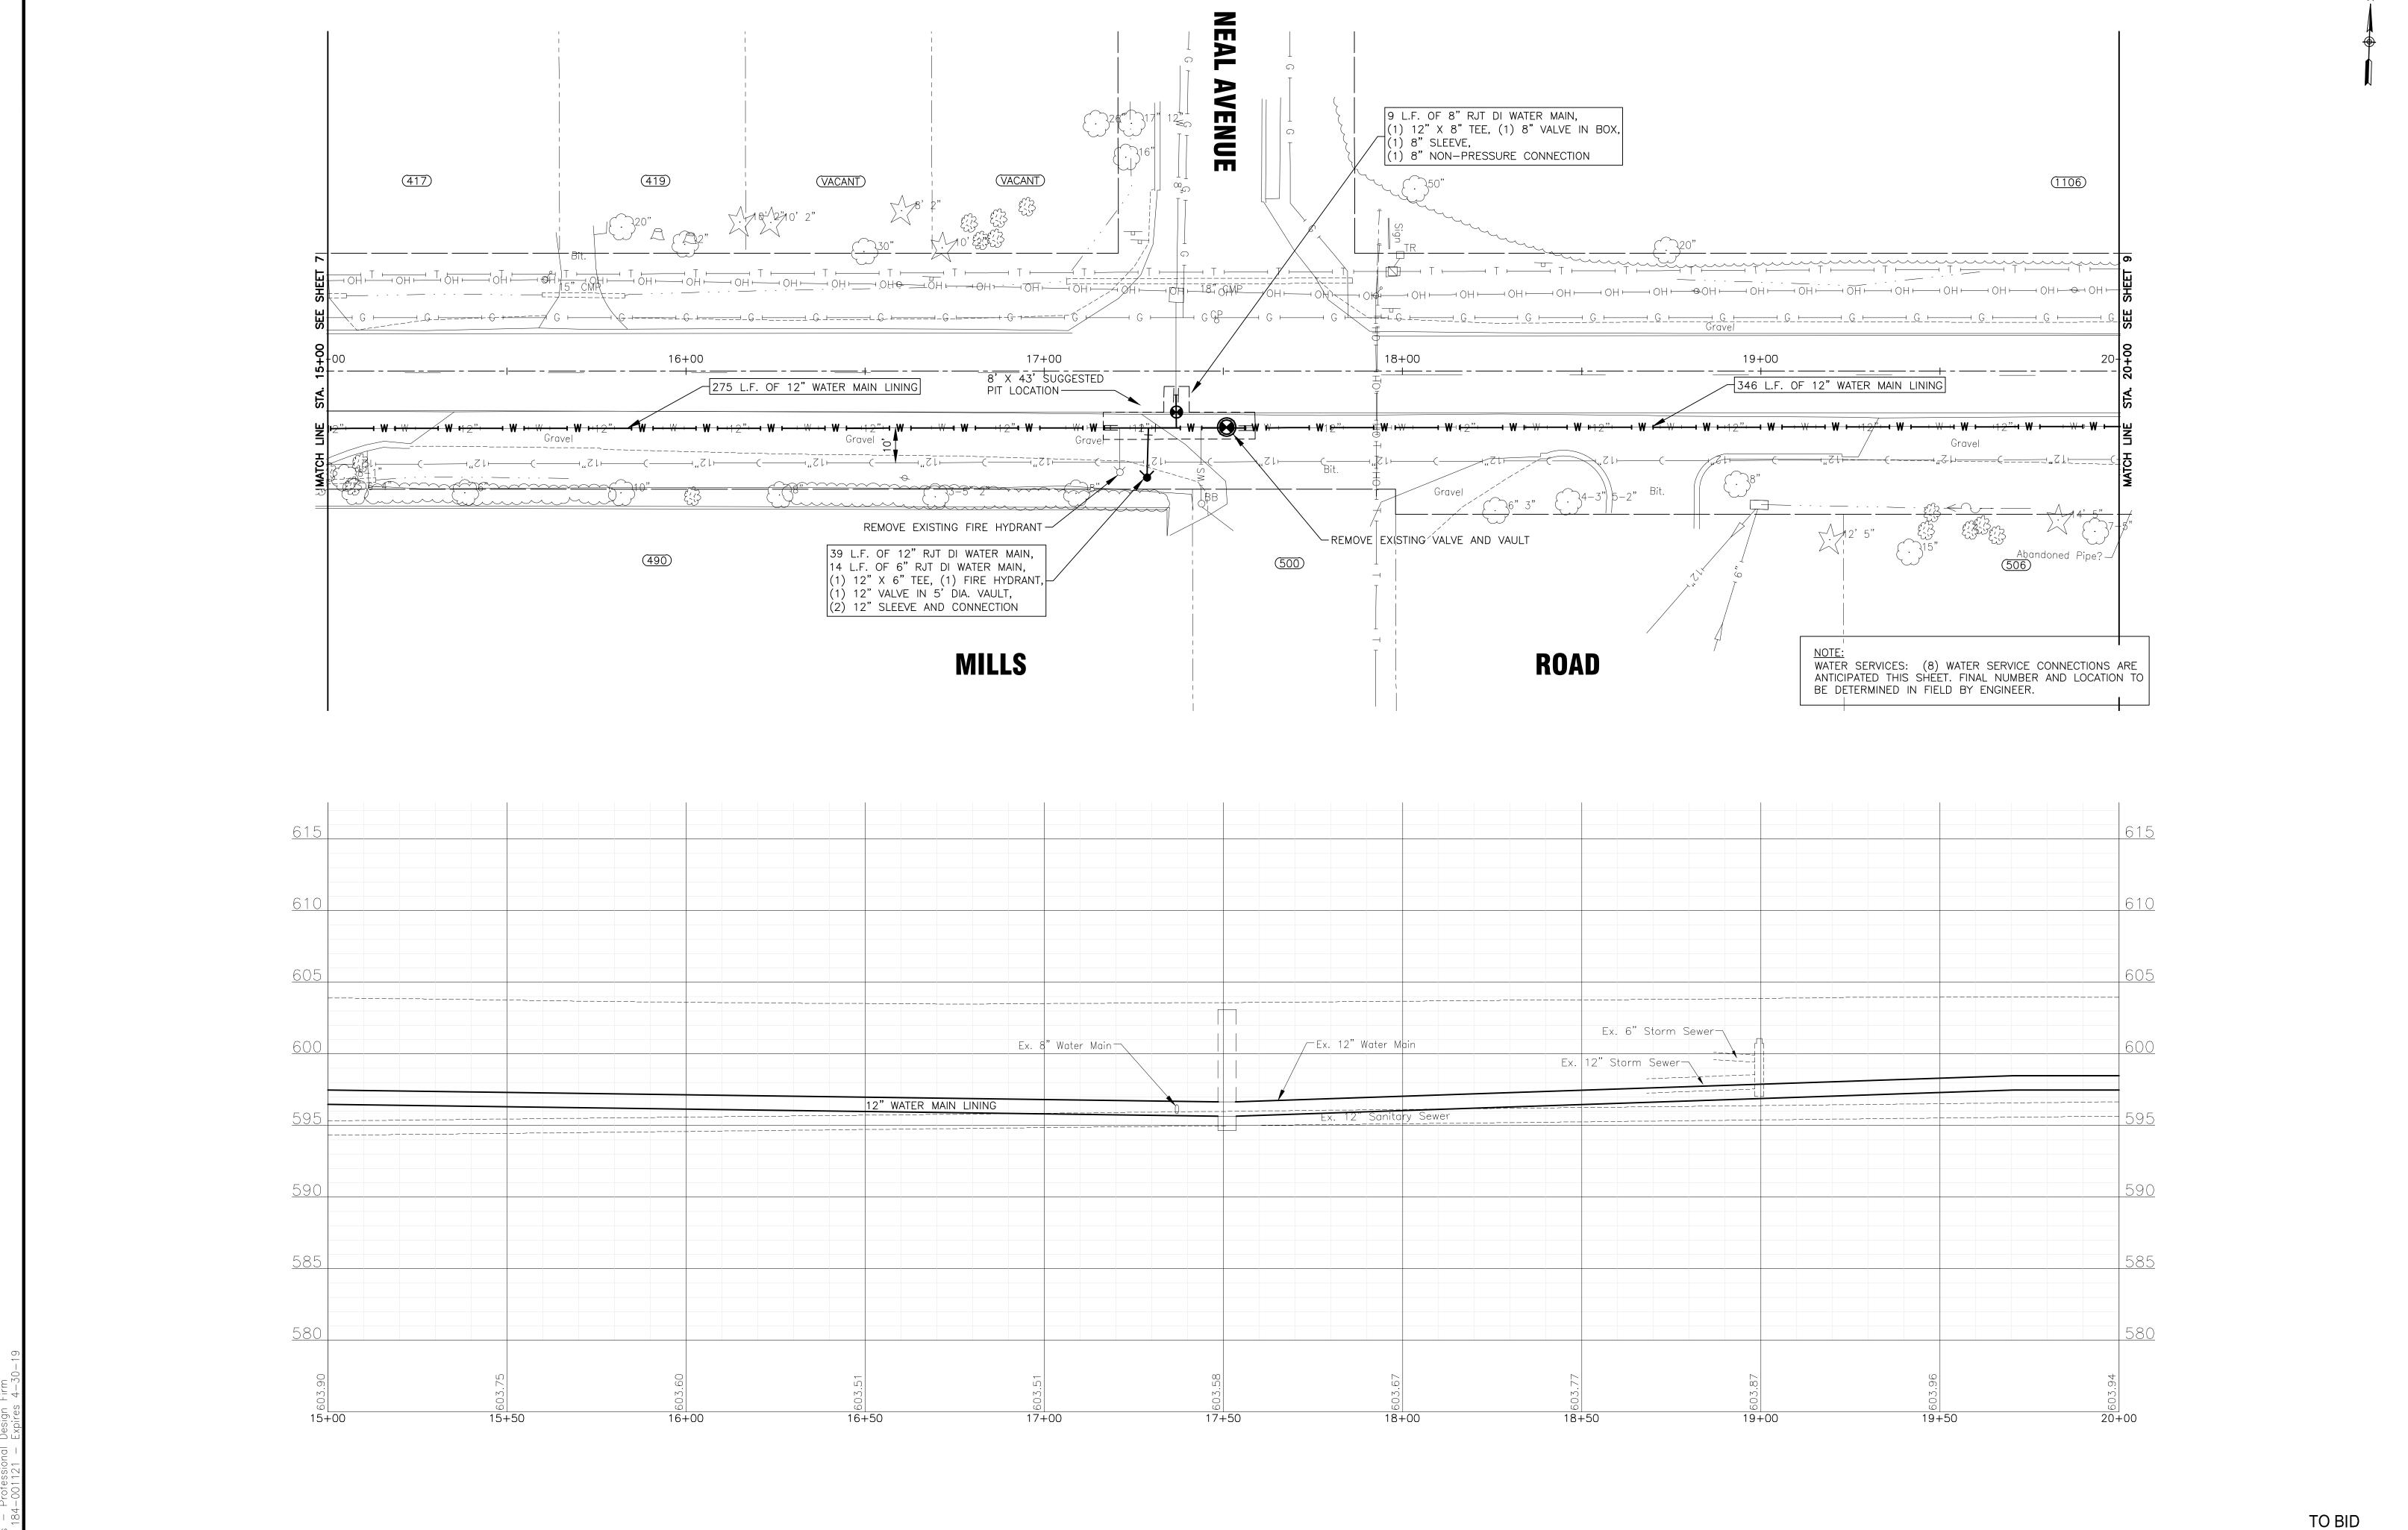


CONSULTANTS REVISED -CITY OF JOLIET, ILLINOIS BAXTER WOODMAN REVISED -MILLS ROAD WATER MAIN IMPROVEMENTS REVISED -REVISED -SCALE:

MILLS ROAD STA. 15+00 TO STA. 20+00 PLAN AND PROFILE

DESIGNED - ARS DRAWN - TJB/ABN CHECKED - LMS 18 8 **DATE –** 10–23–19

HORIZ 1"=20' / VERT 1"=5'

PROJECT NO: 190223.40

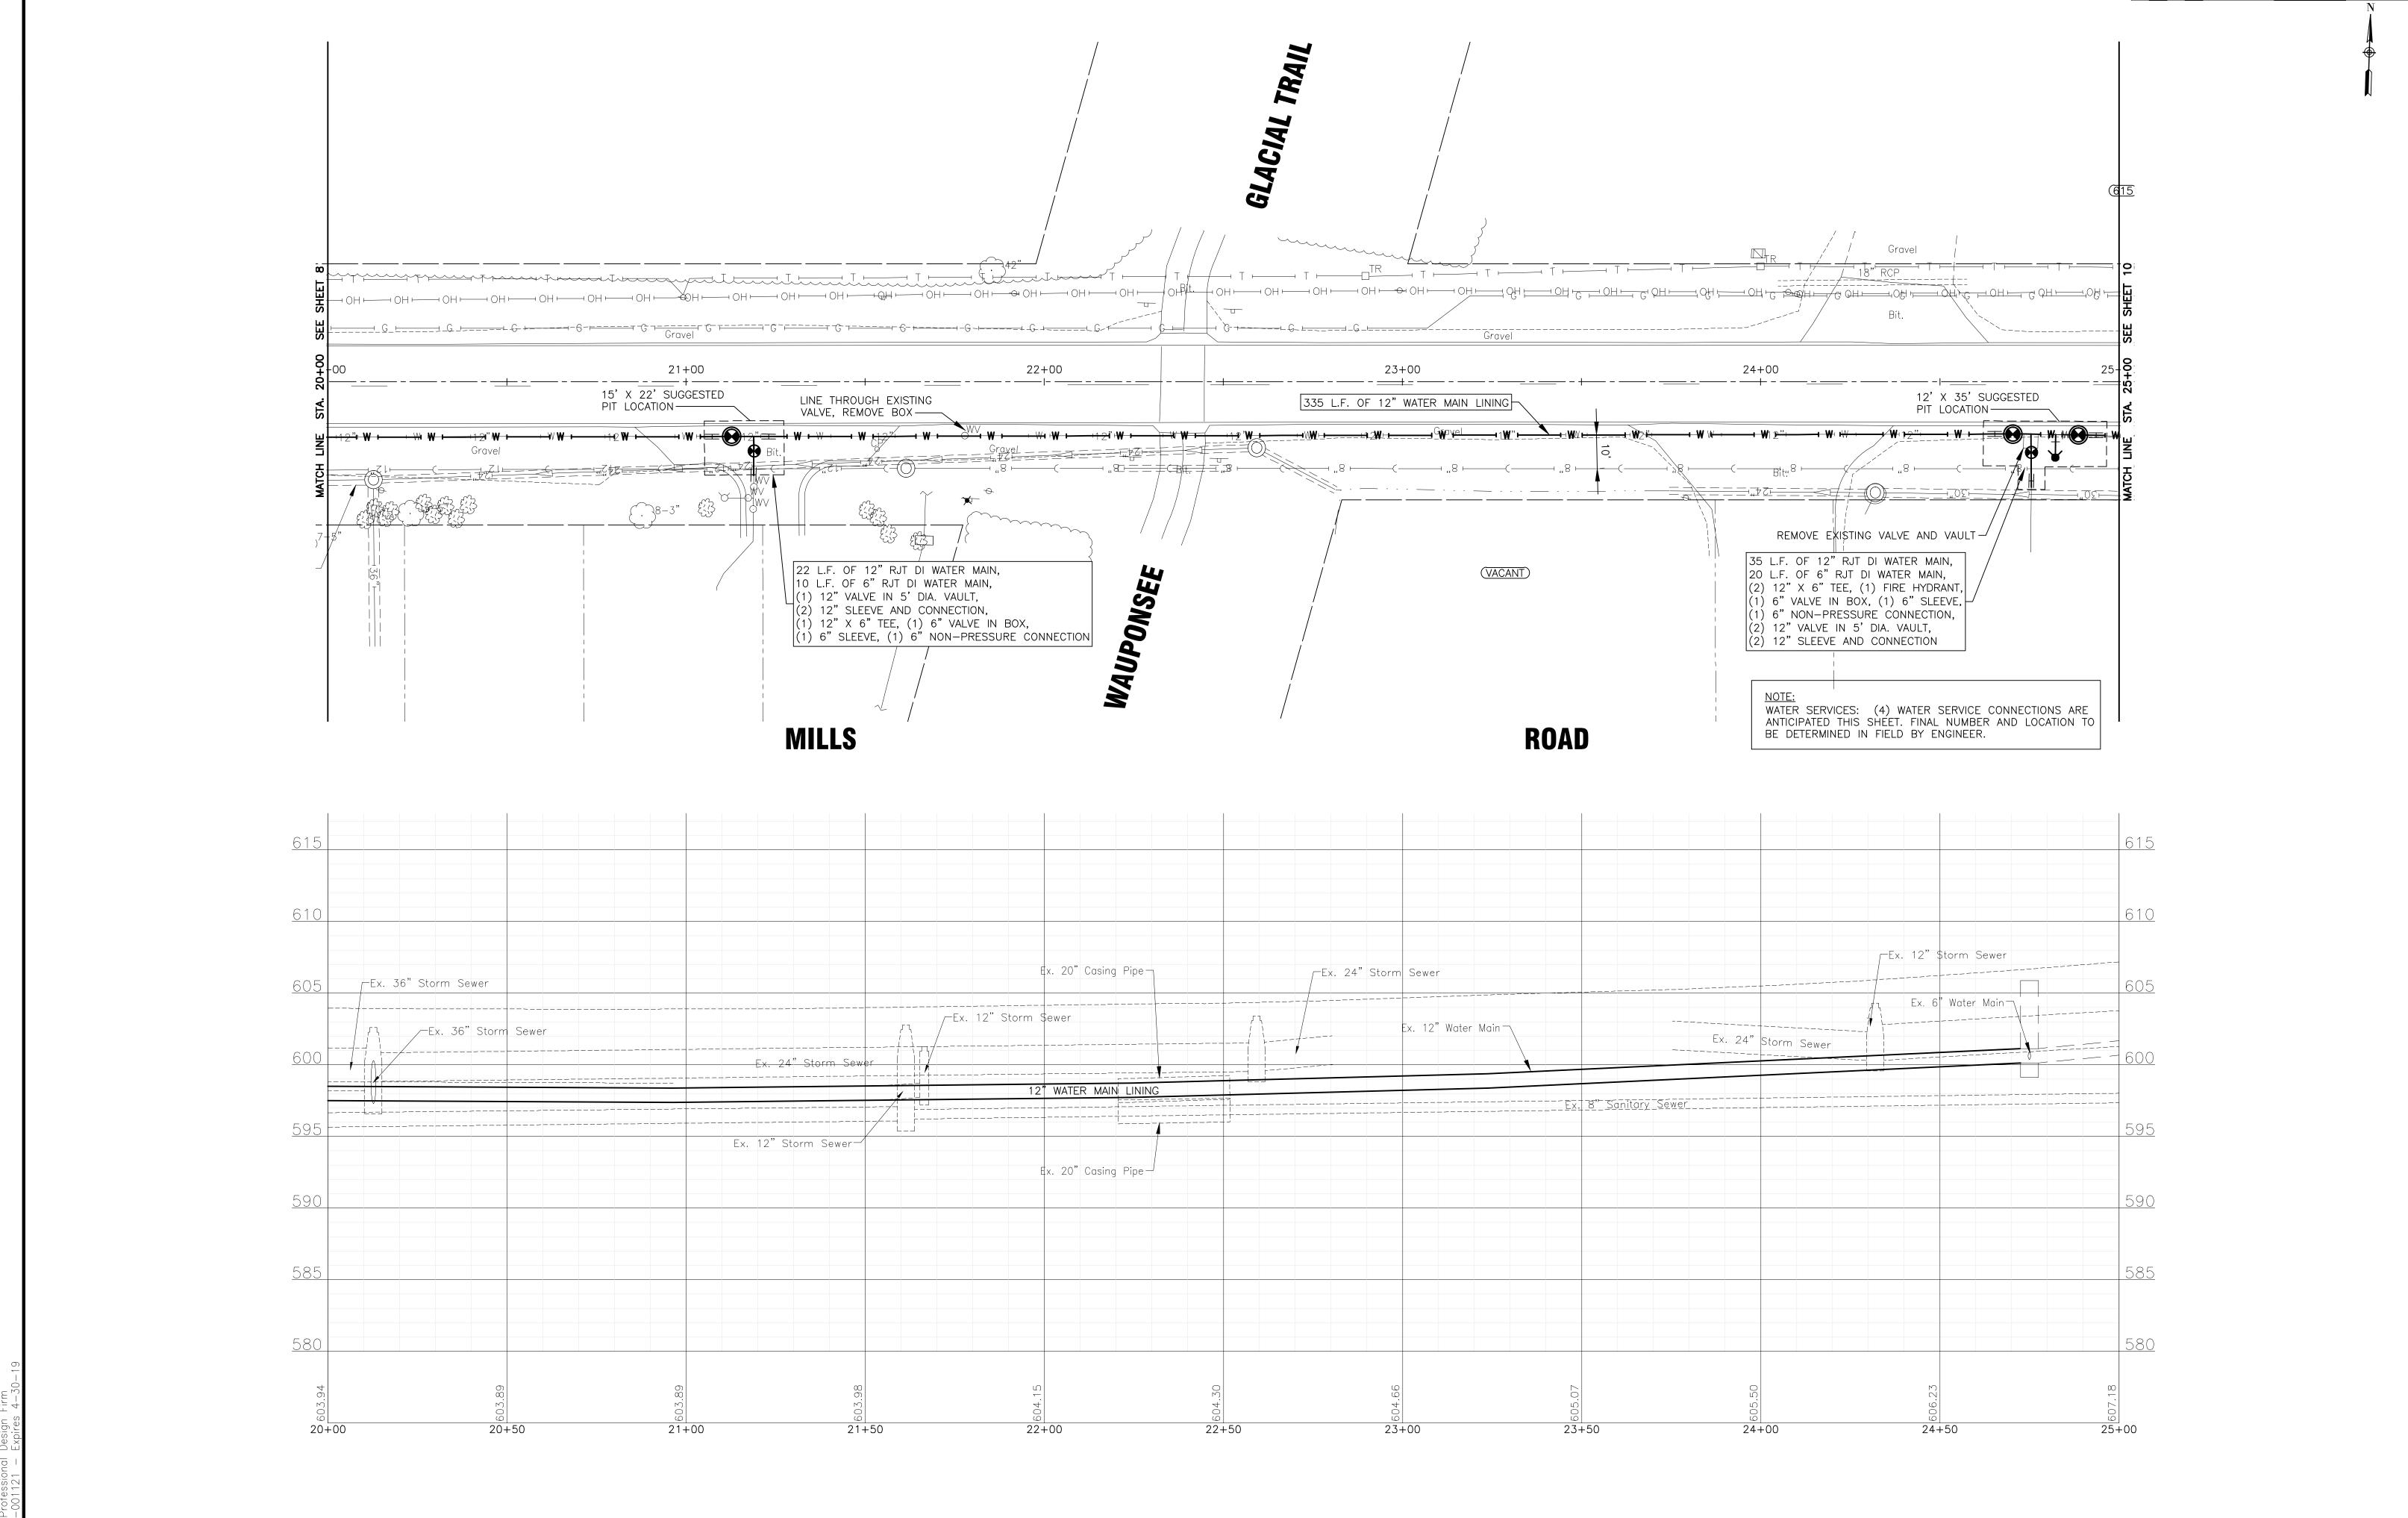

TO BID

CONSULTANTS REVISED -BAXTER WOODMAN REVISED -REVISED -REVISED -


CITY OF JOLIET, ILLINOIS MILLS ROAD WATER MAIN IMPROVEMENTS

MILLS ROAD STA. 20+00 TO STA. 25+00 PLAN AND PROFILE HORIZ 1"=20' / VERT 1"=5' PROJECT NO: 190223.40

SCALE:

DESIGNED - ARS DRAWN — TJB/ABN CHECKED - LMS **DATE** - 10-23-19

TOTAL SHEET NO. 18 9

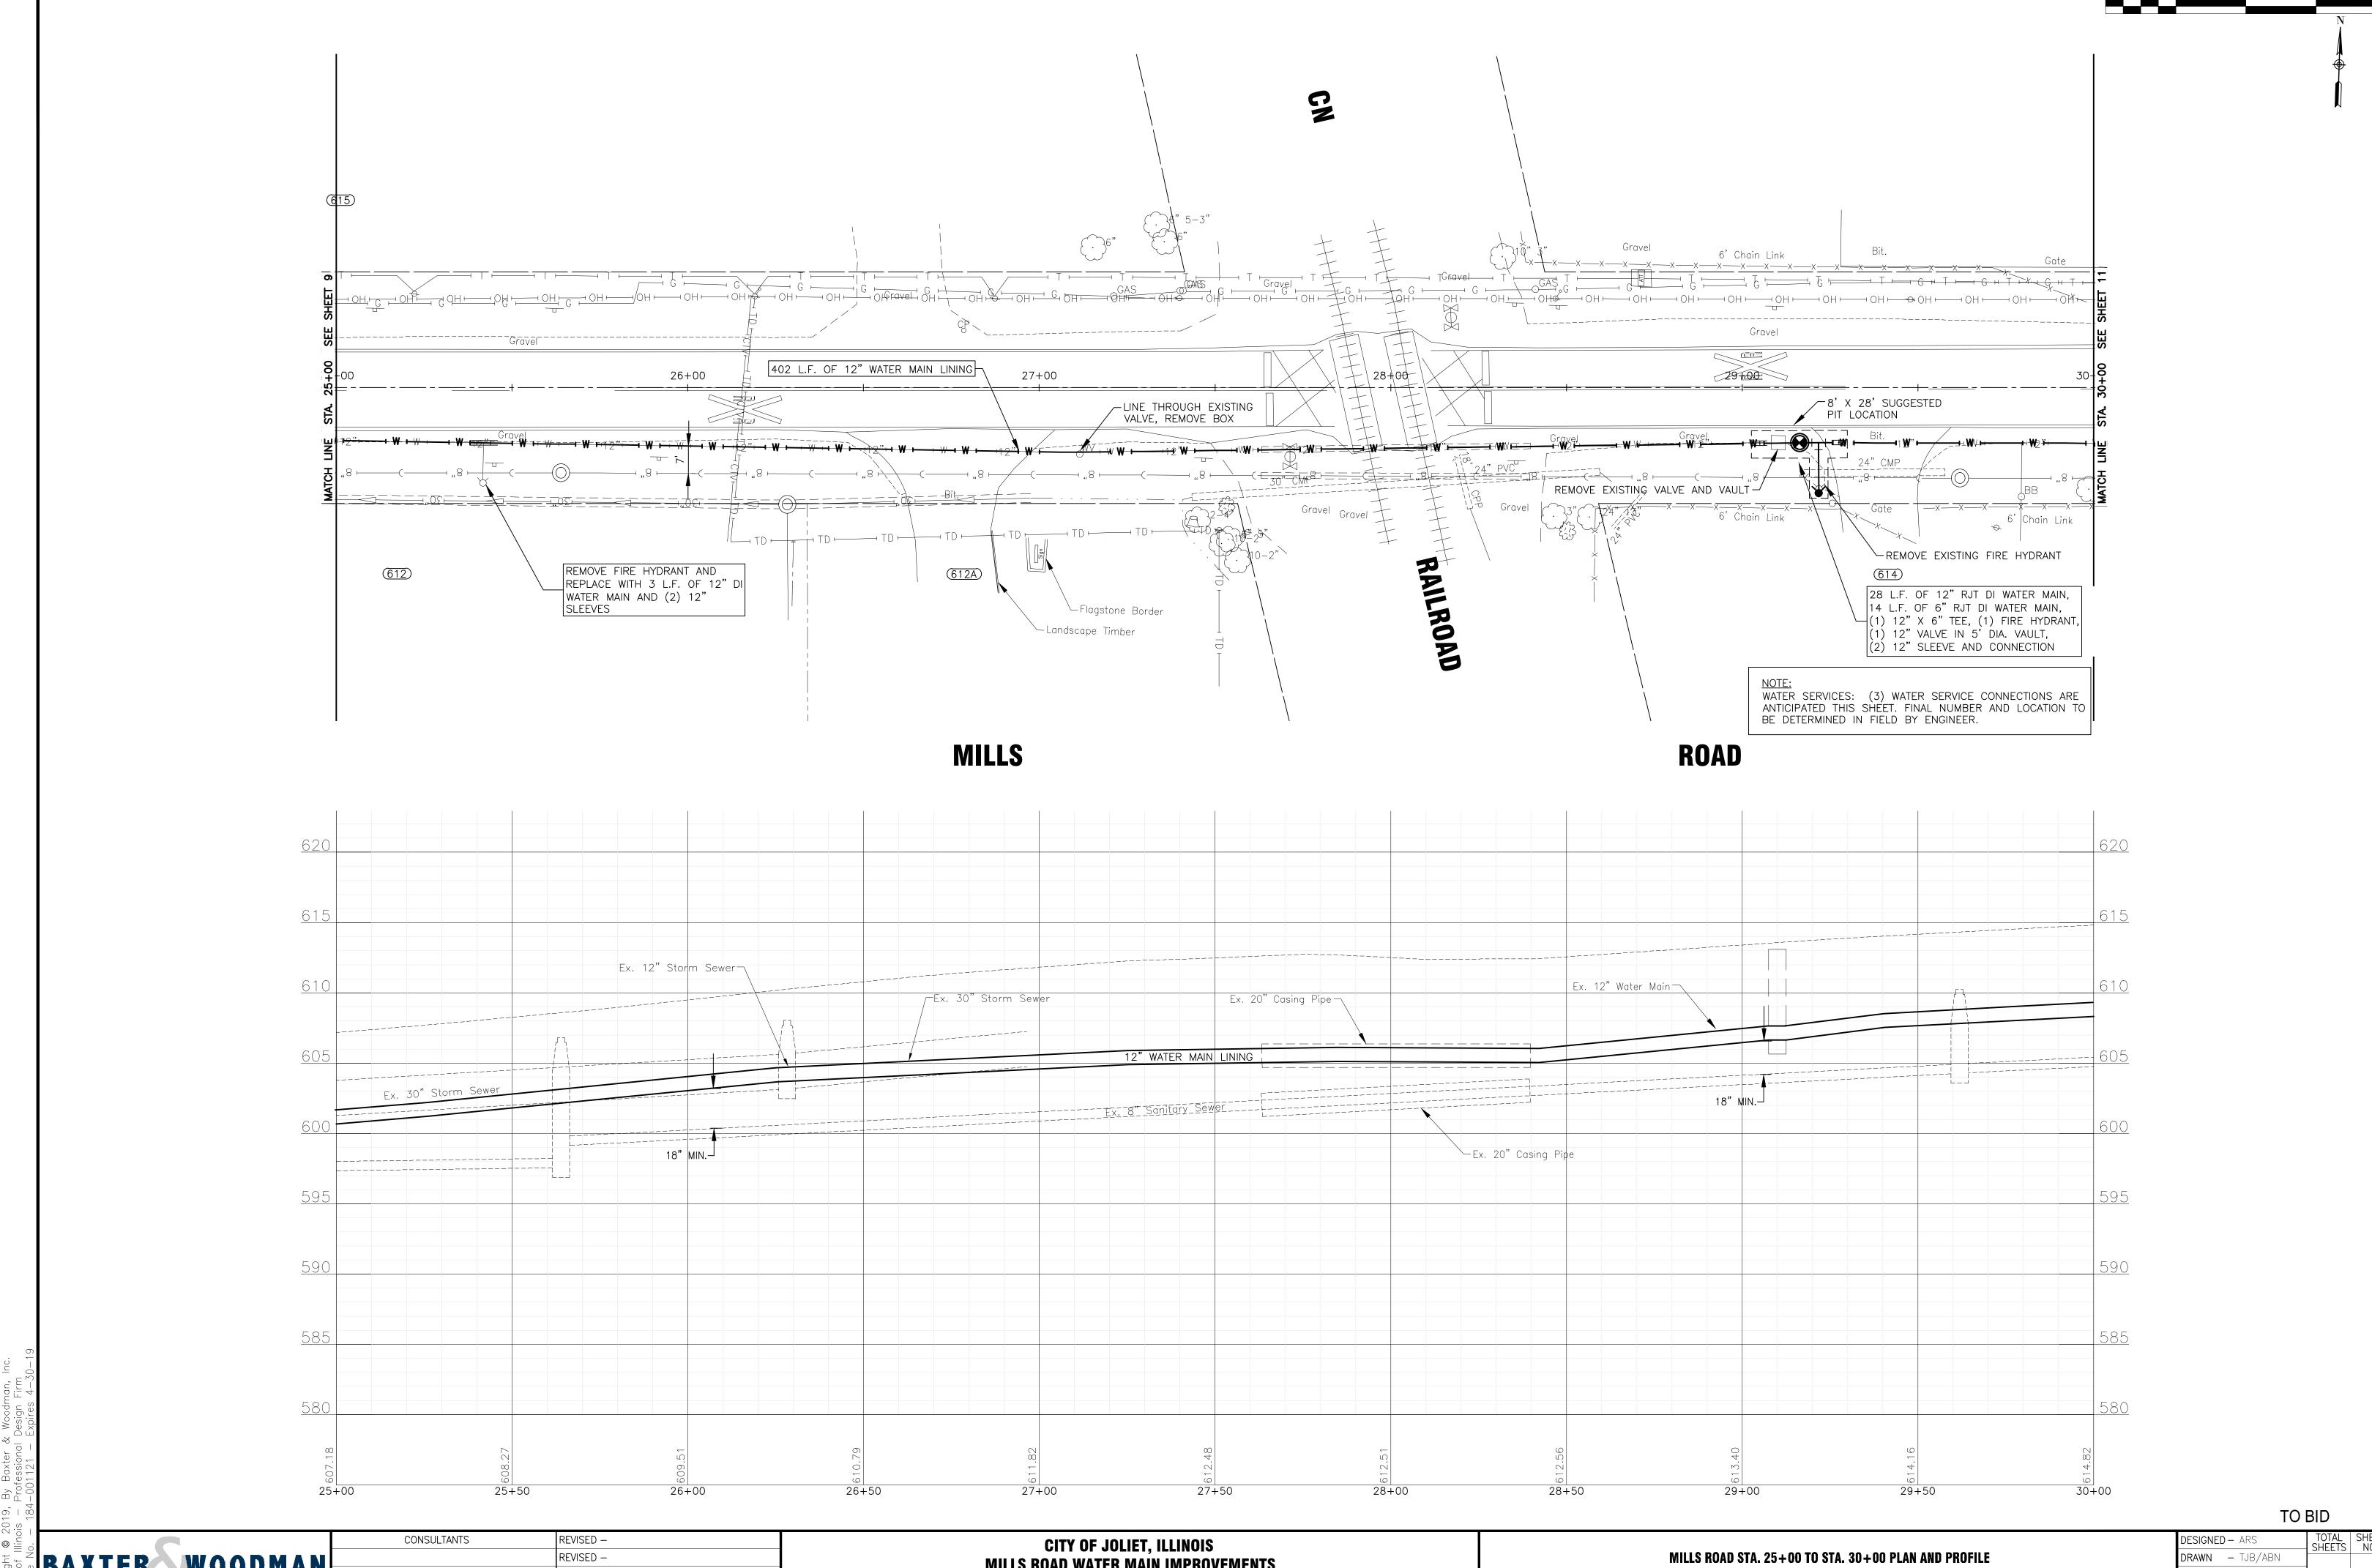


BAXTER WOODMAN

REVISED -REVISED - MILLS ROAD WATER MAIN IMPROVEMENTS


HORIZ 1"=20' / VERT 1"=5' PROJECT NO: 190223.40

SCALE:

CHECKED - LMS **DATE** - 10-23-19

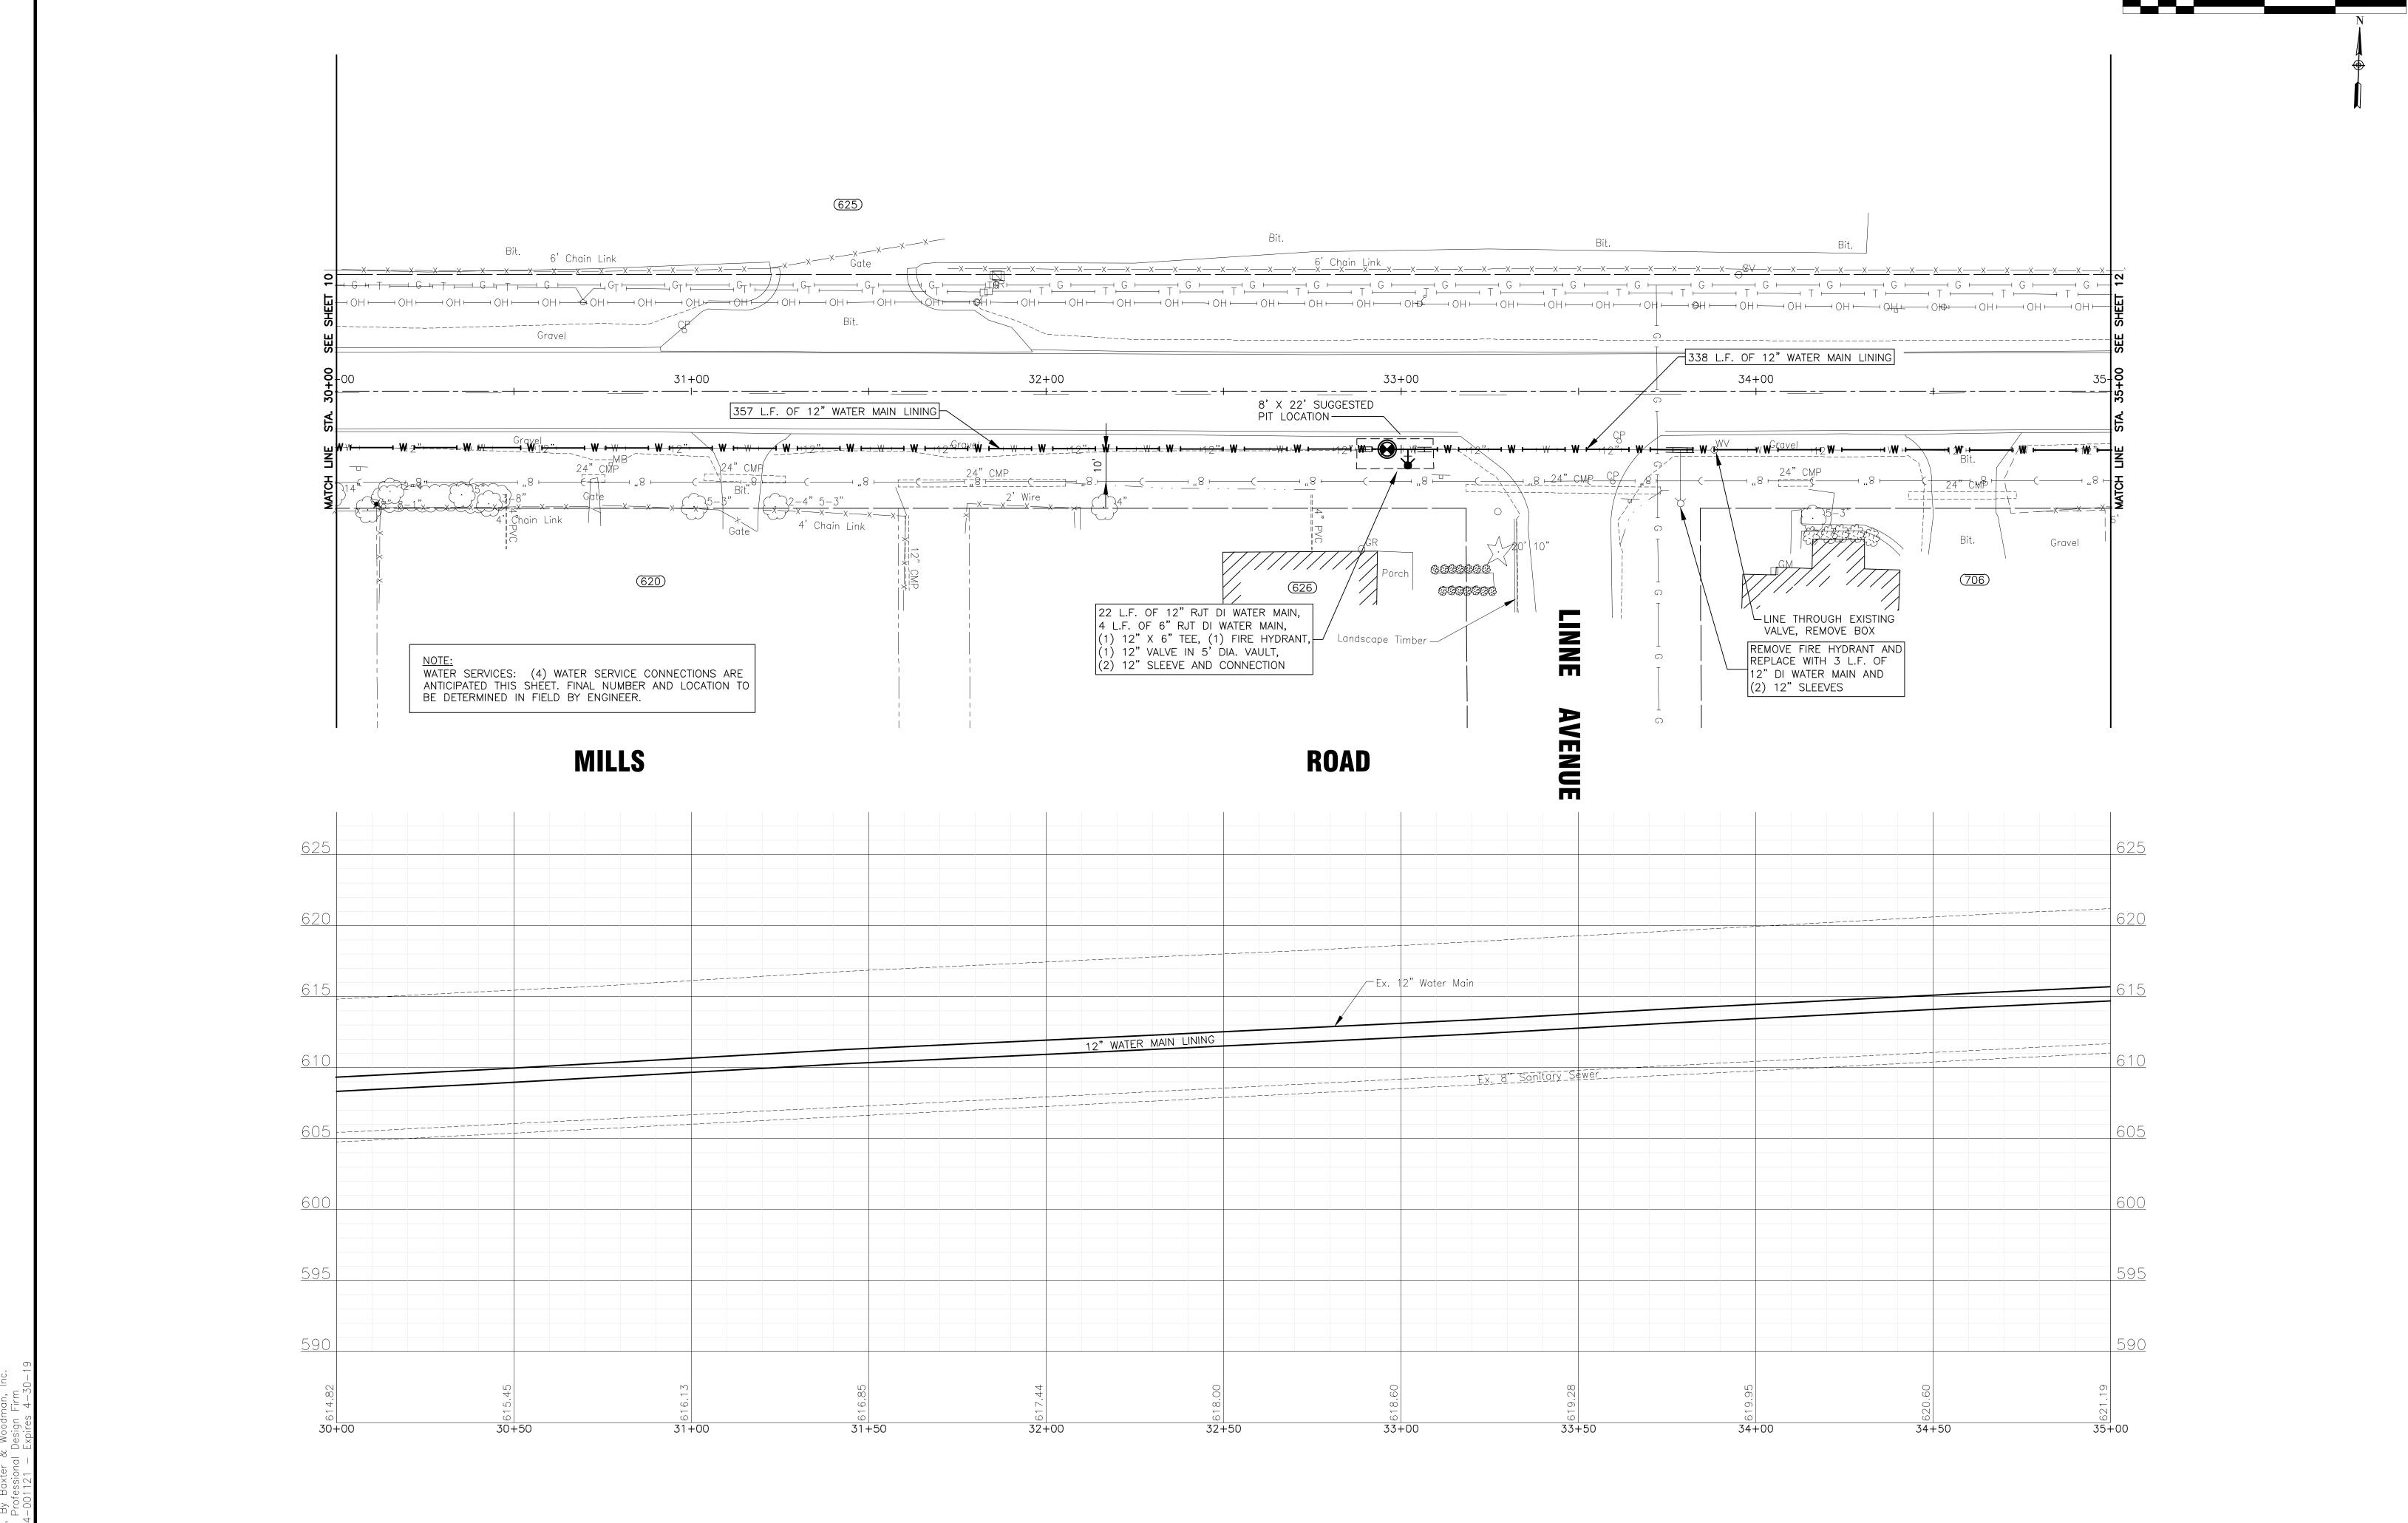

TO BID CONSULTANTS REVISED -CITY OF JOLIET, ILLINOIS BAXTER WOODMAN DRAWN — TJB/ABN REVISED -MILLS ROAD STA. 30+00 TO STA. 35+00 PLAN AND PROFILE MILLS ROAD WATER MAIN IMPROVEMENTS CHECKED - LMS REVISED -18 11 **DATE** - 10-23-19 REVISED -SCALE: HORIZ 1"=20' / VERT 1"=5' PROJECT NO: 190223.40

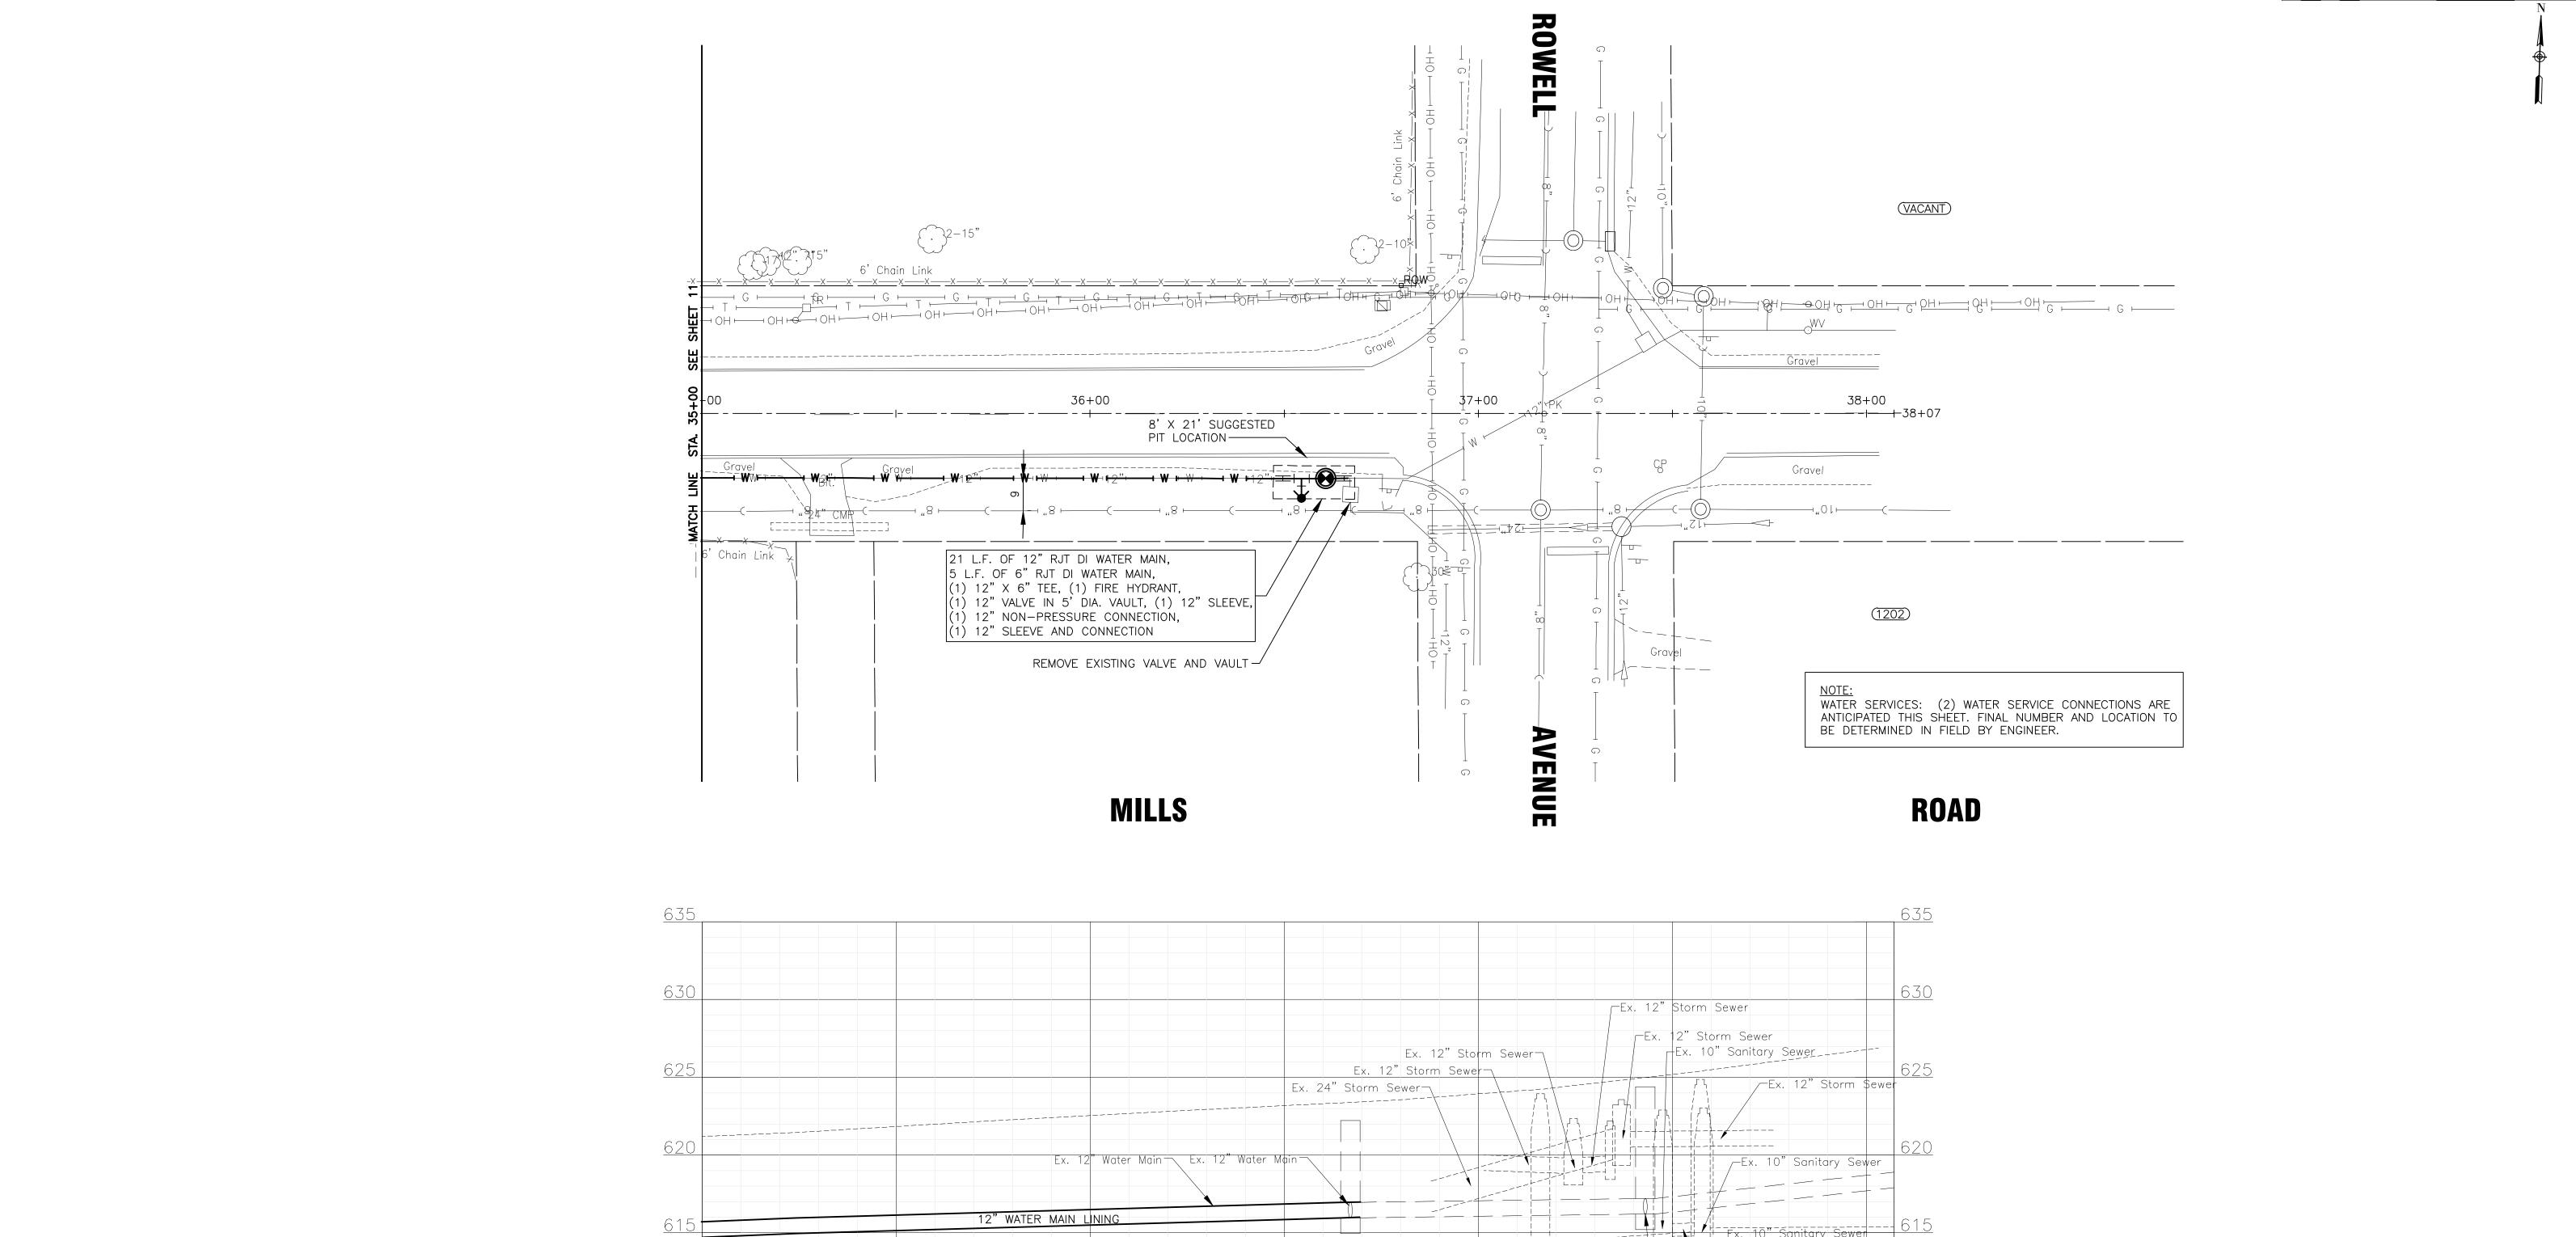


550

520

521 Storm Sear | Lx. 2' Storm Sear |

TO BID

CONSULTANTS REVISED -CITY OF JOLIET, ILLINOIS DRAWN — TJB/ABN BAXTER WOODMAN REVISED -MILLS ROAD STA. 35+00 TO STA. 38+00 PLAN AND PROFILE MILLS ROAD WATER MAIN IMPROVEMENTS CHECKED - LMS REVISED -18 12 **DATE** - 10-23-19 HORIZ 1"=20' / VERT 1"=5' REVISED -SCALE: PROJECT NO: 190223.40

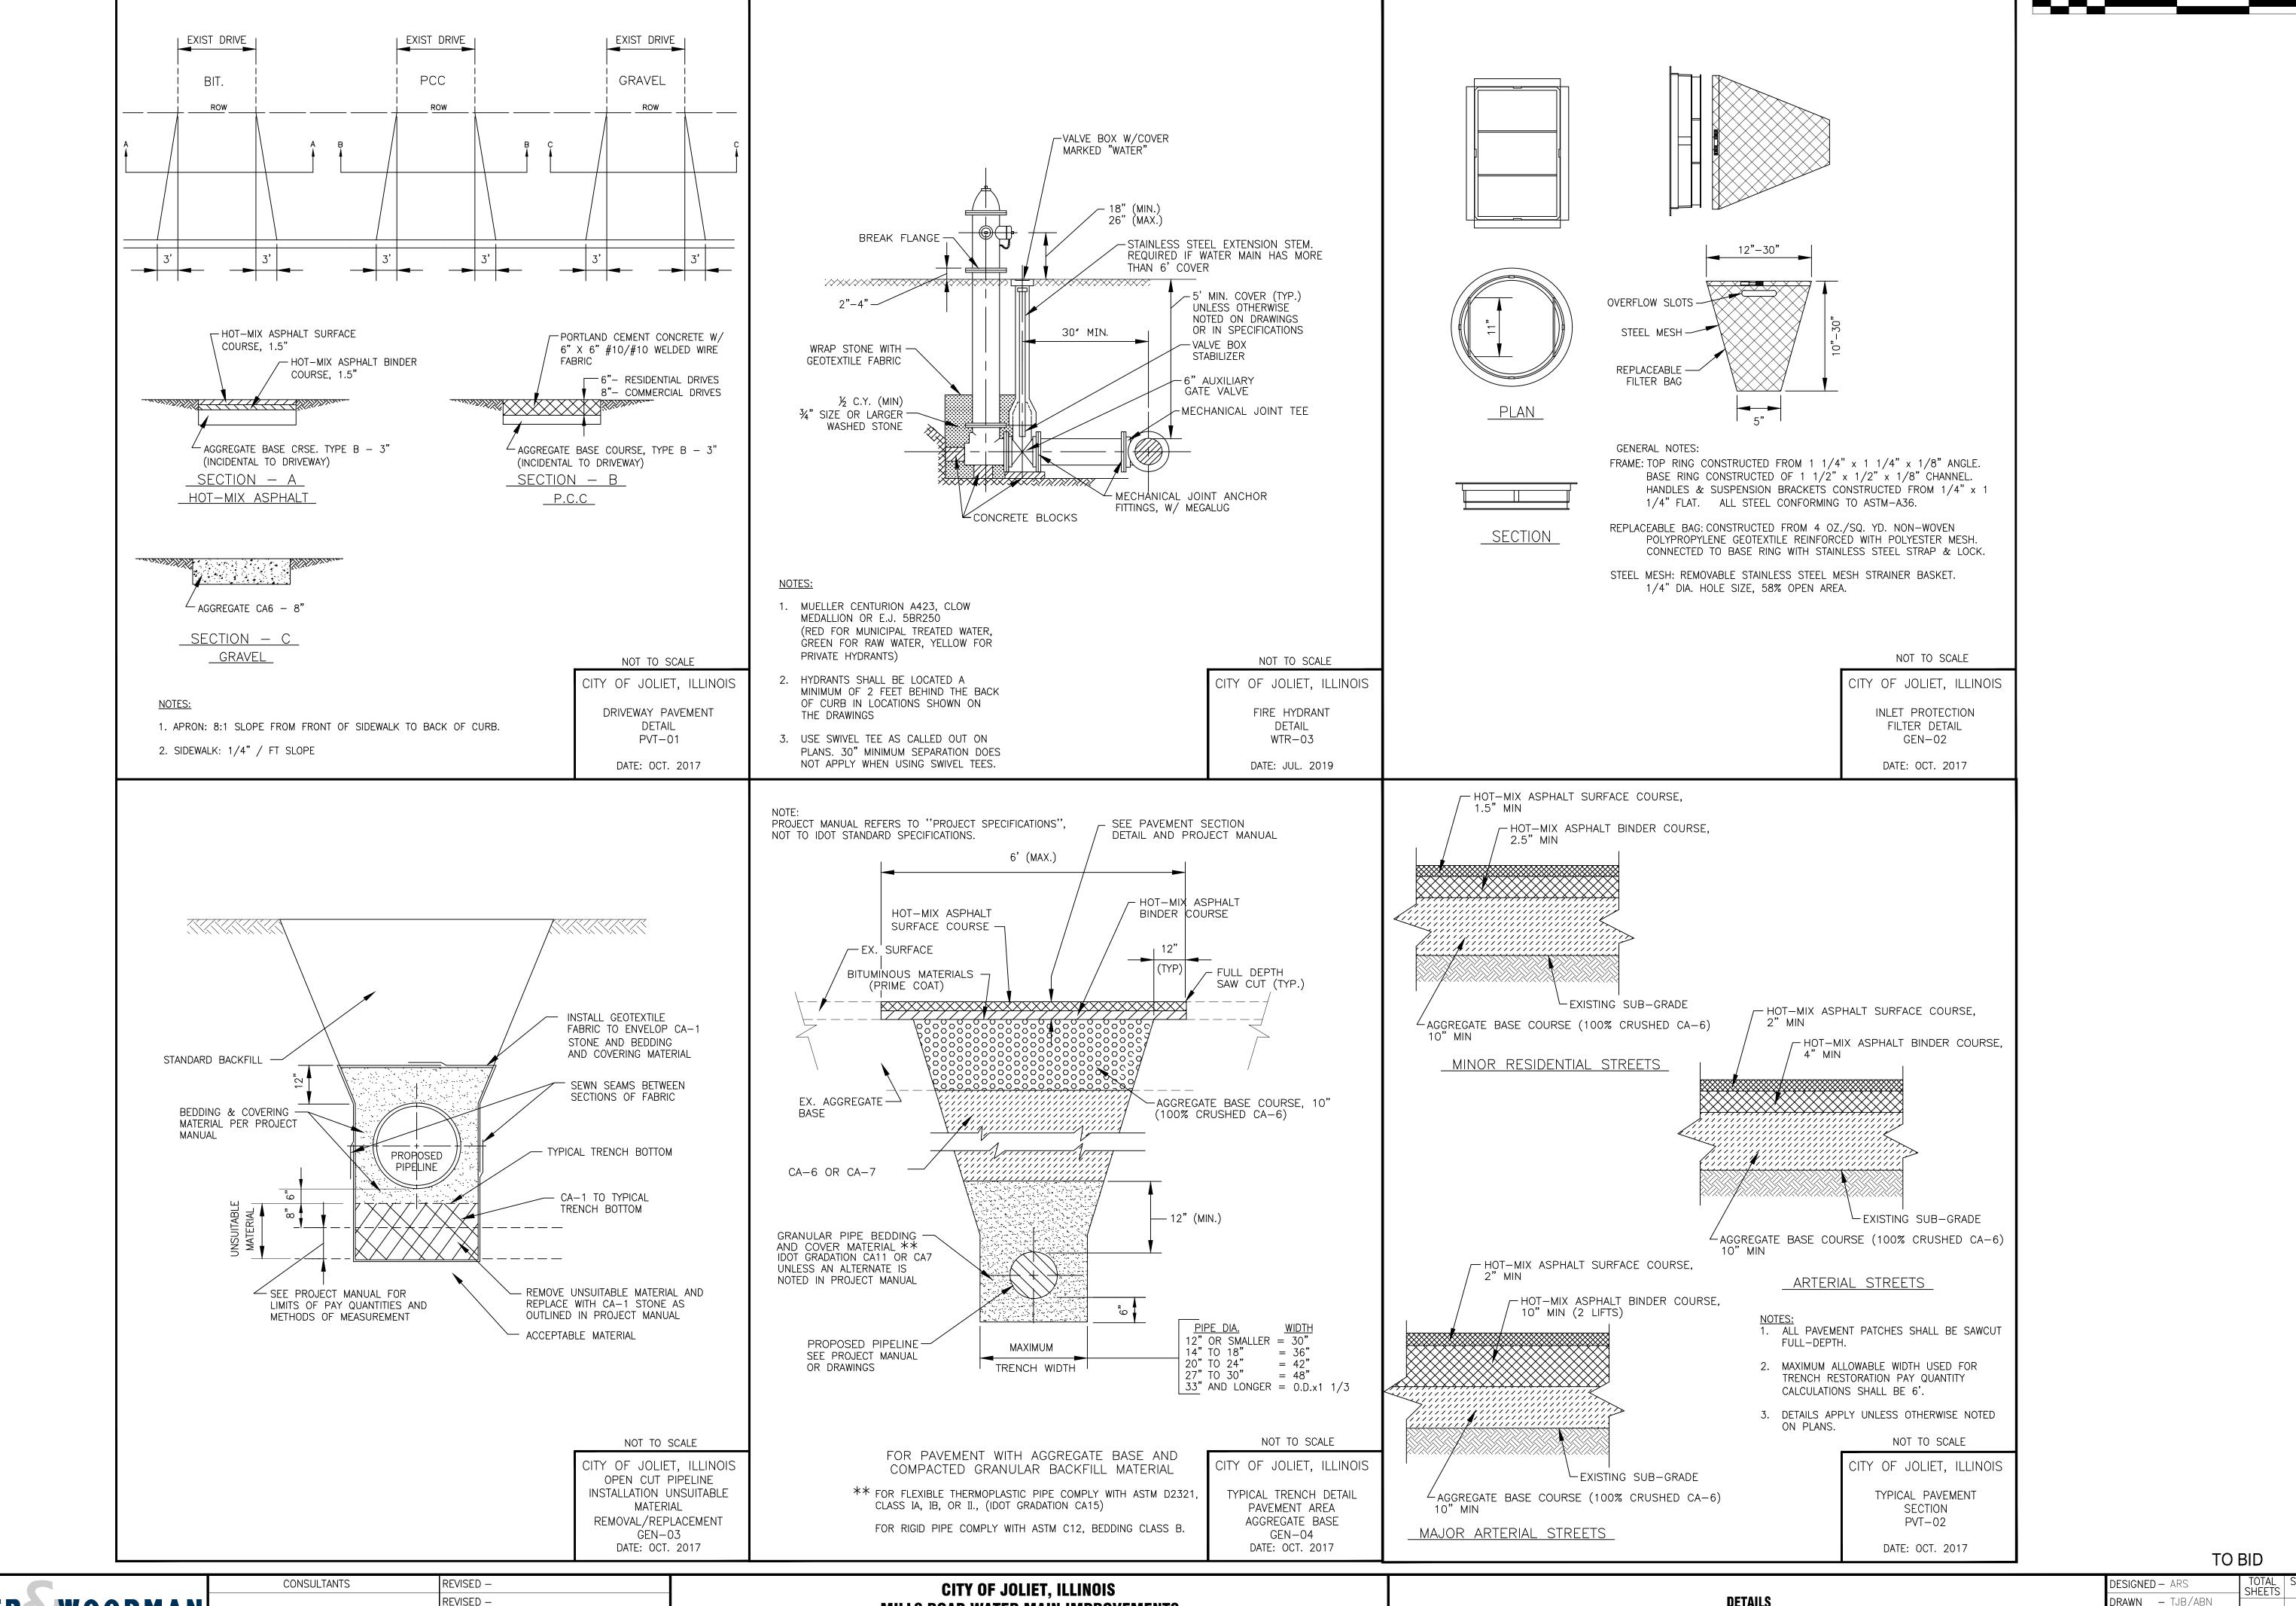


BAXTER WOODMAN

REVISED -REVISED -REVISED - MILLS ROAD WATER MAIN IMPROVEMENTS

DETAILS SCALE: PROJECT NO: AS NOTED

DRAWN - TJB/ABN CHECKED - LMS **DATE** - 10-23-19

190223.40

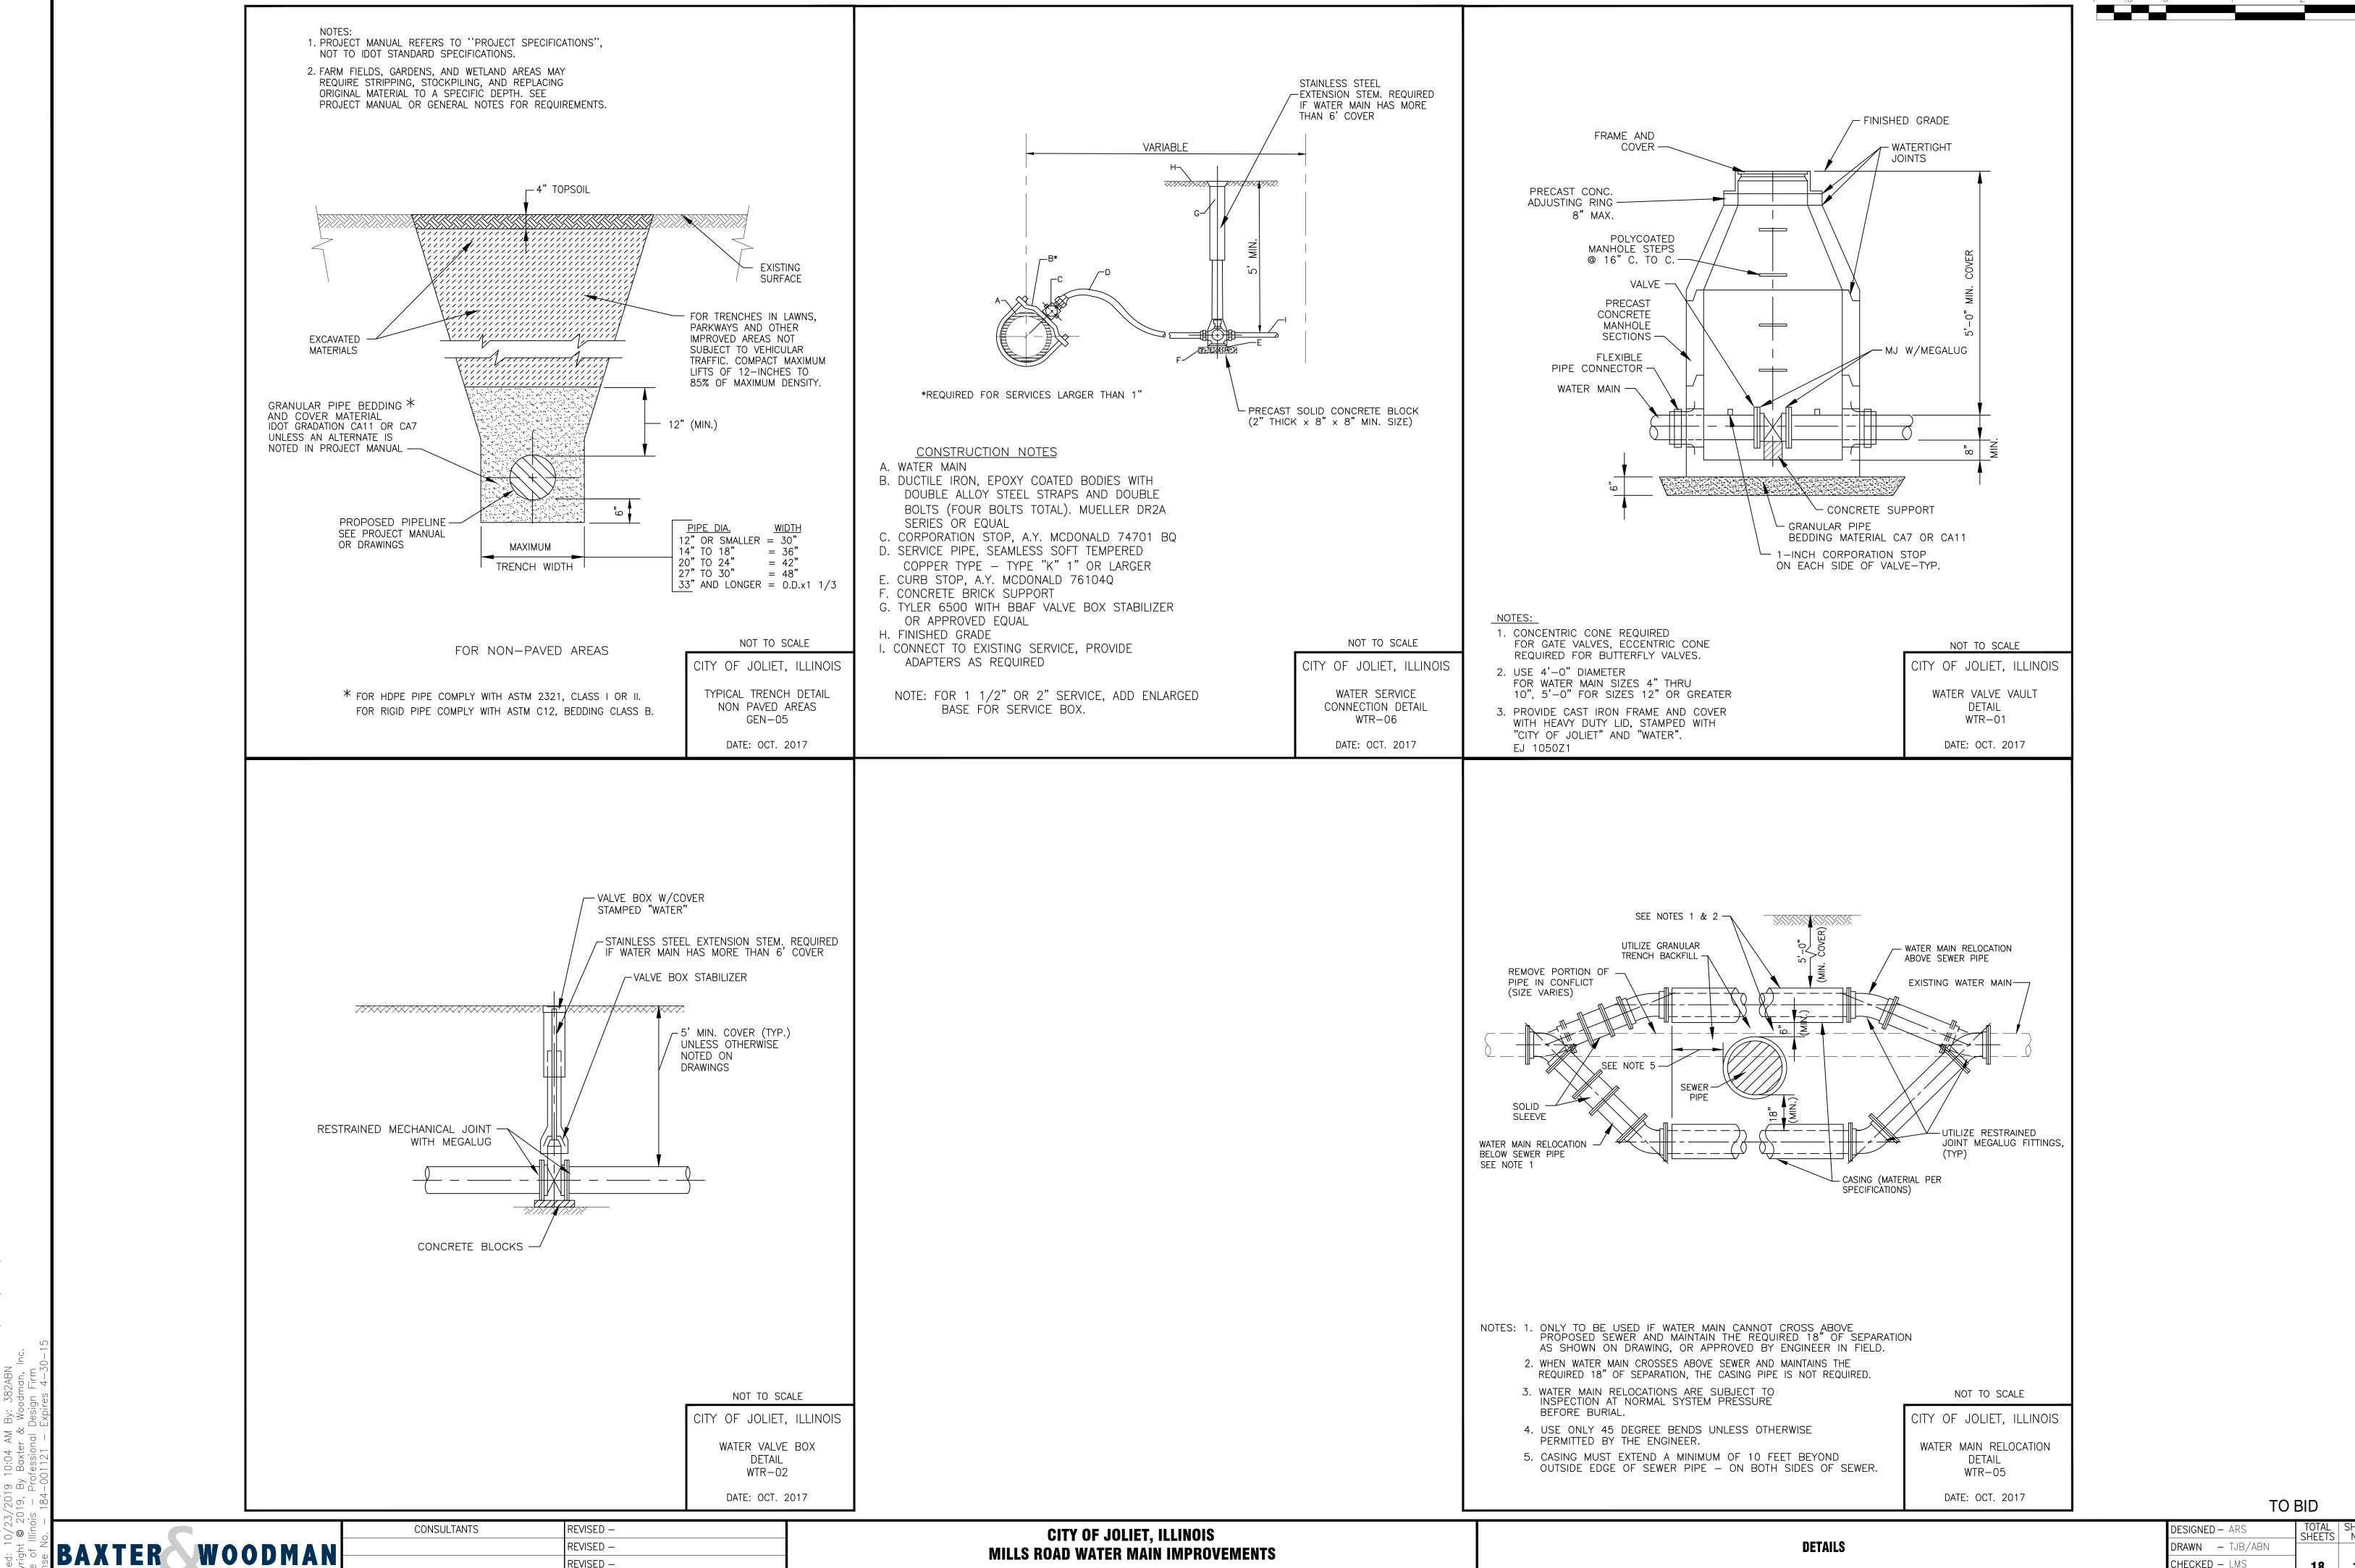

REVISED -

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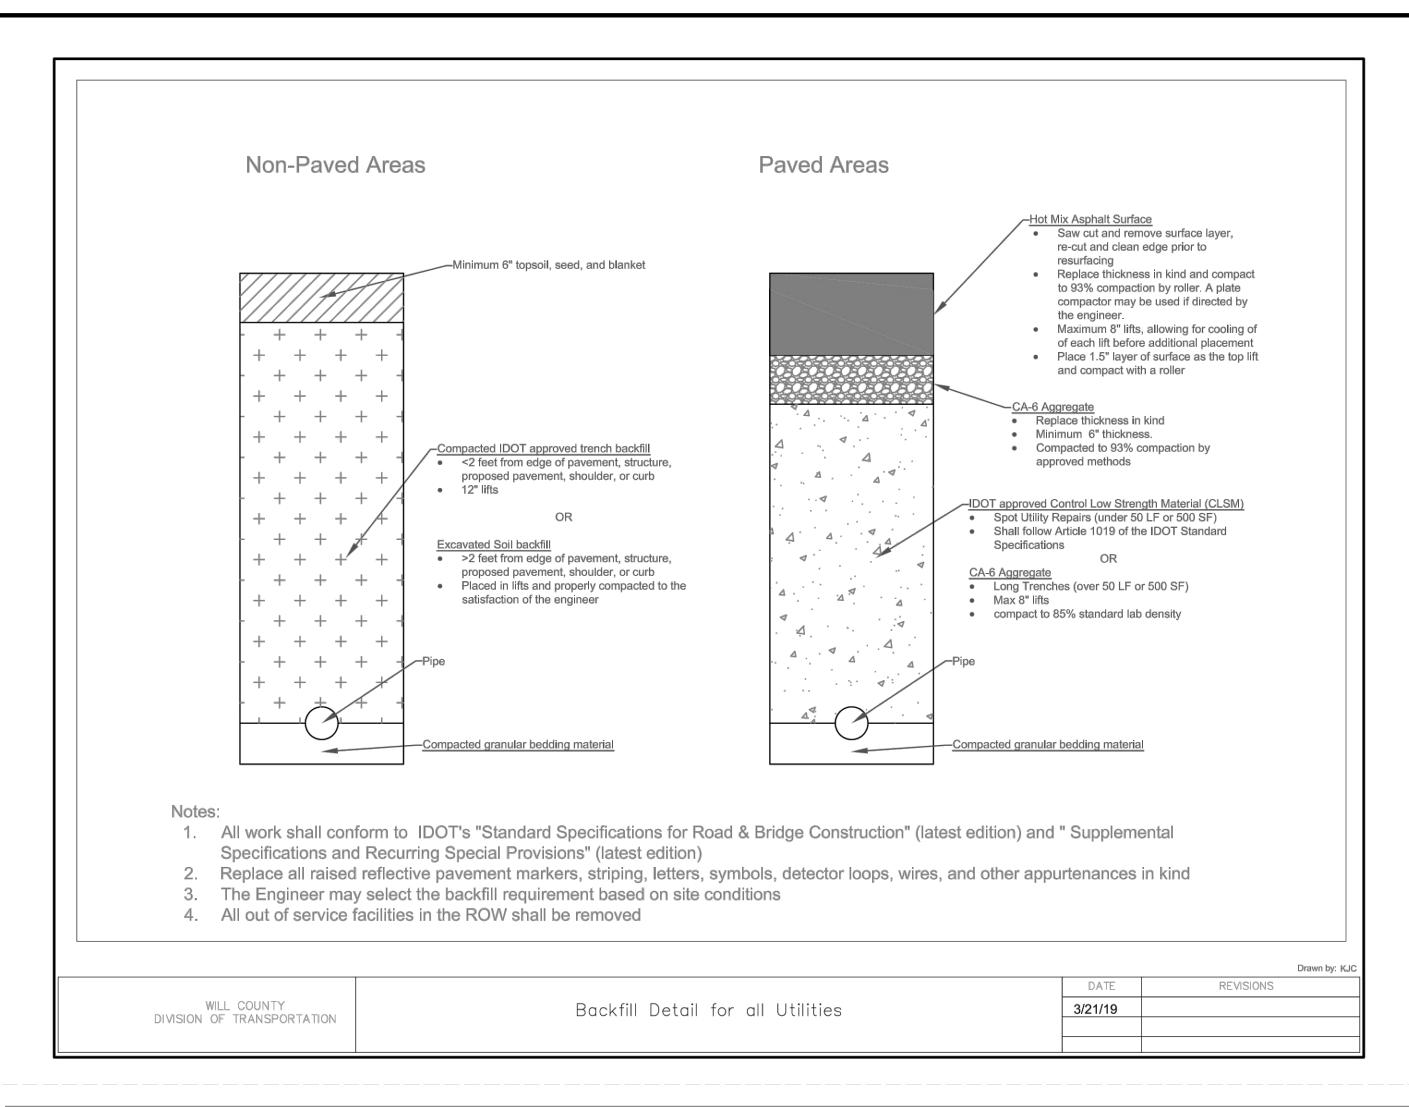
MILLS ROAD WATER MAIN IMPROVEMENTS


PROJECT NO:


HECKED - LMS **DATE** - 10-23-19


SCALE: AS NOTED

190223.40



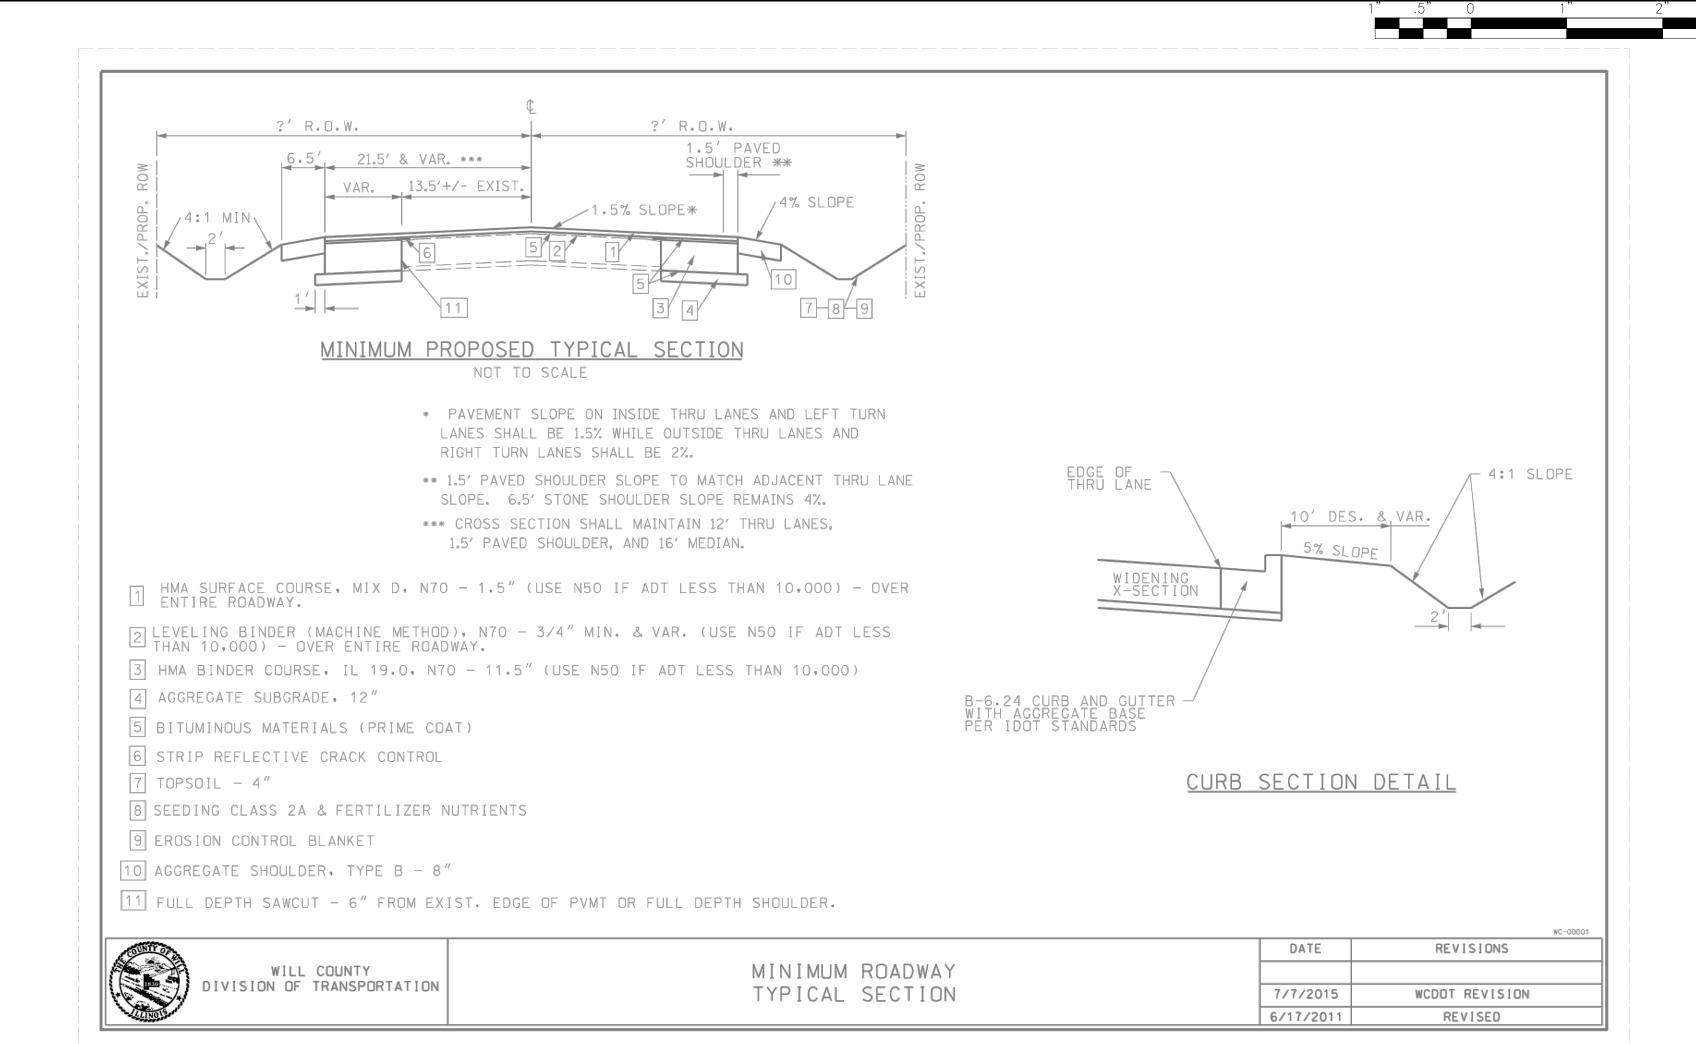

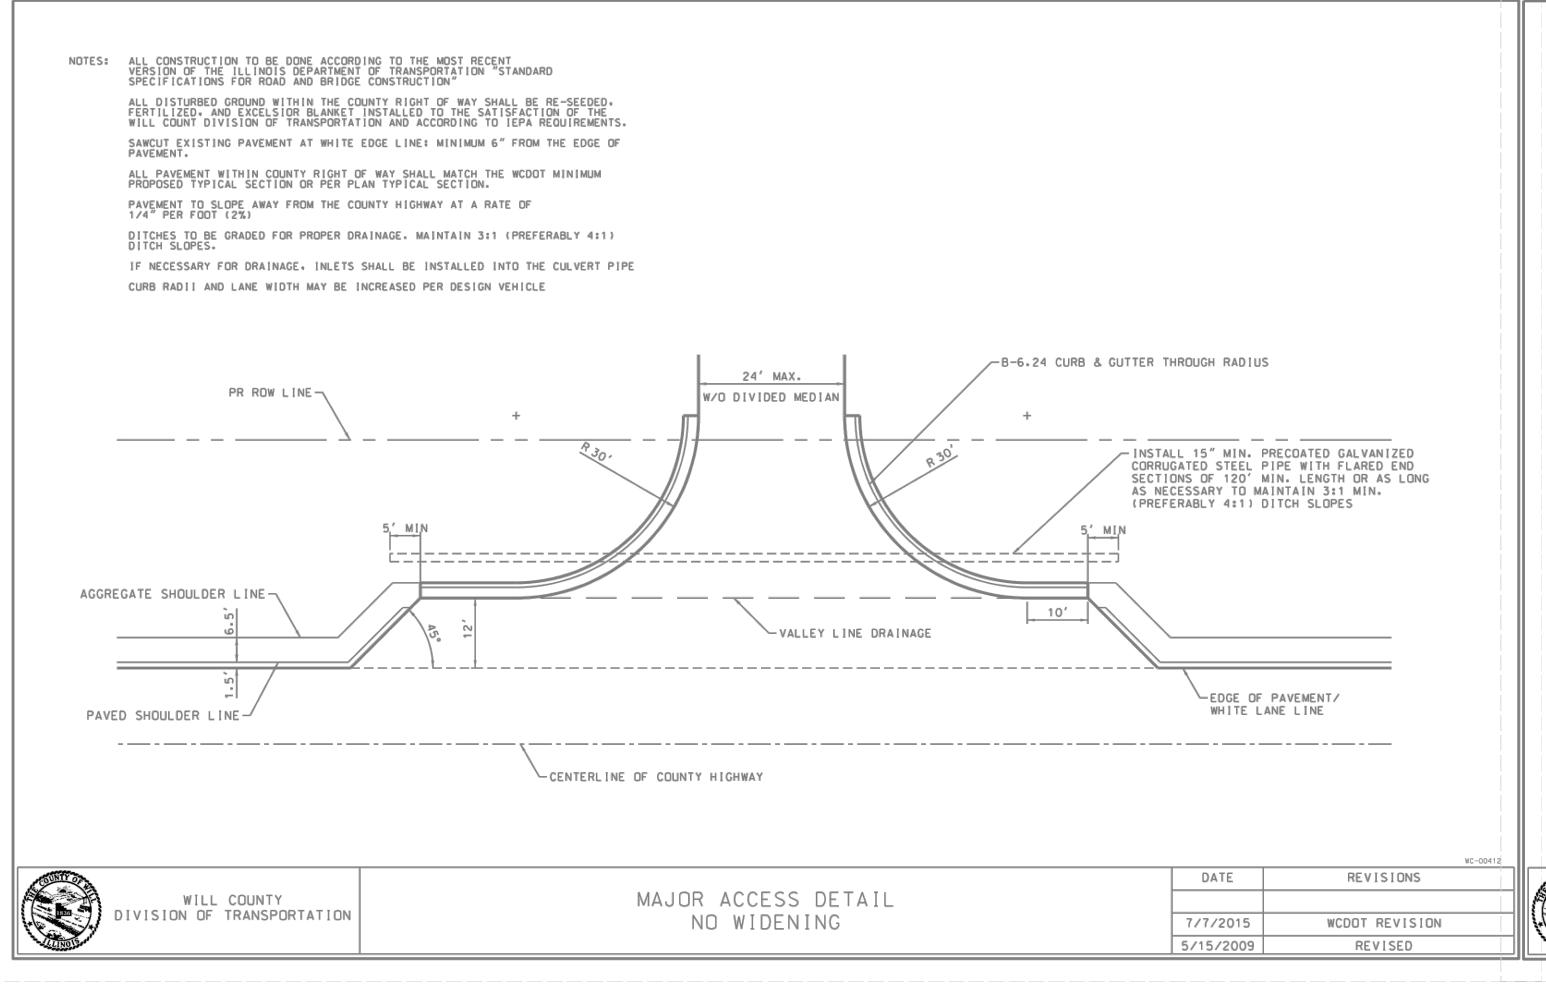


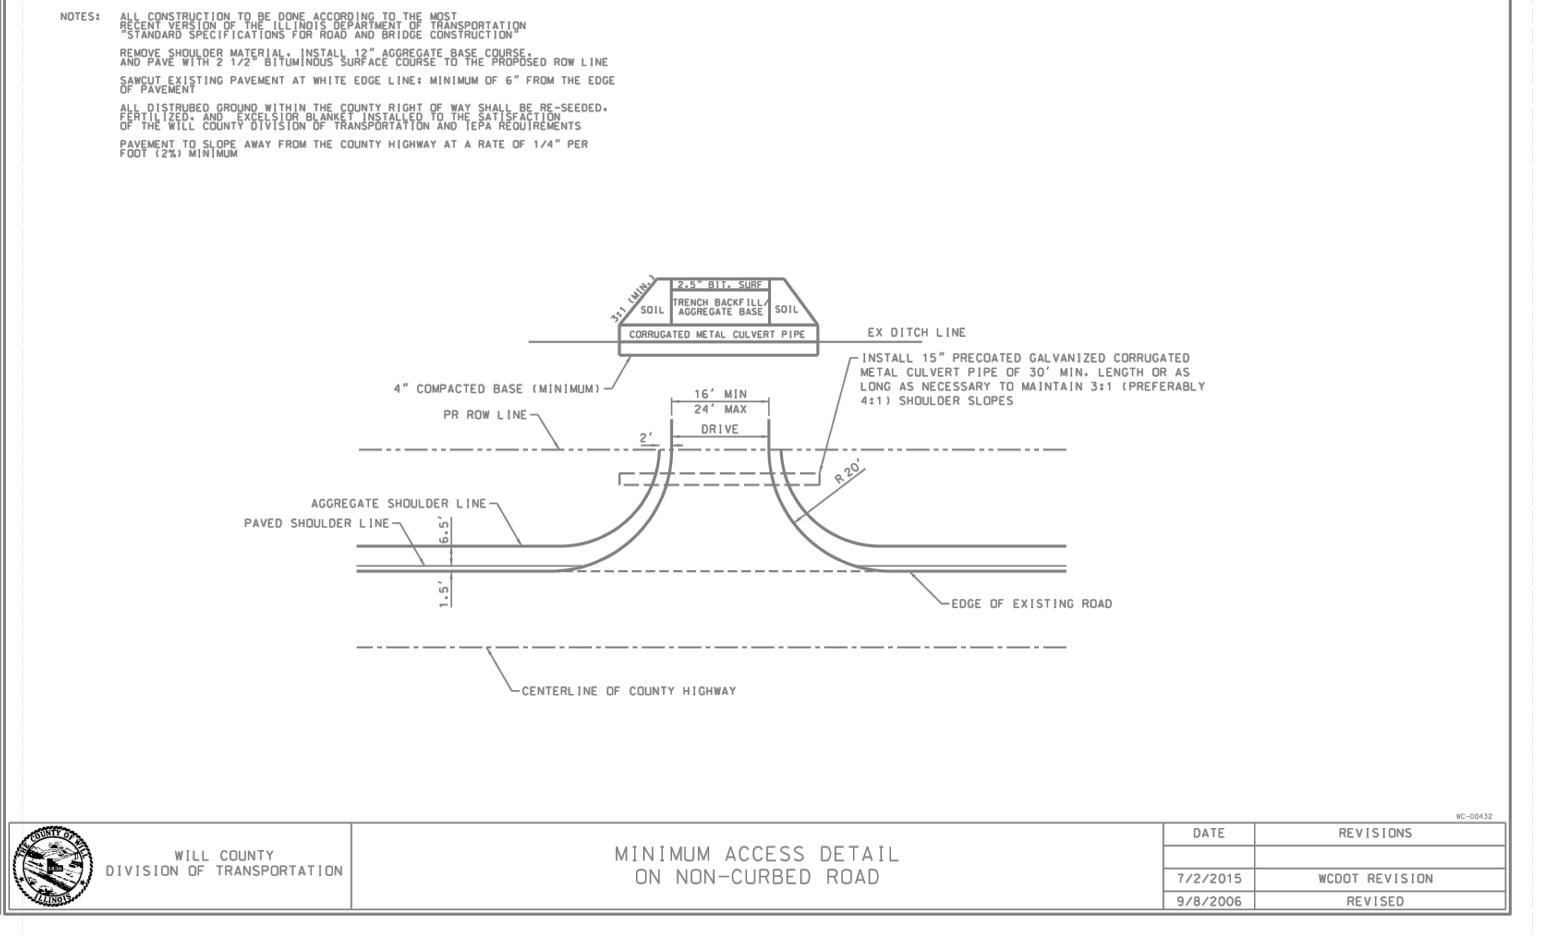

TO BID

CONSULTANTS REVISED -DESIGNED - ARS CITY OF JOLIET, ILLINOIS **DETAILS** BAXTER WOODMAN REVISED -DRAWN - TJB/ABN MILLS ROAD WATER MAIN IMPROVEMENTS REVISED -CHECKED - LMS 18 15 **DATE** - 10-23-19 REVISED -SCALE: PROJECT NO: AS NOTED 190223.40

4 By: 382ABN

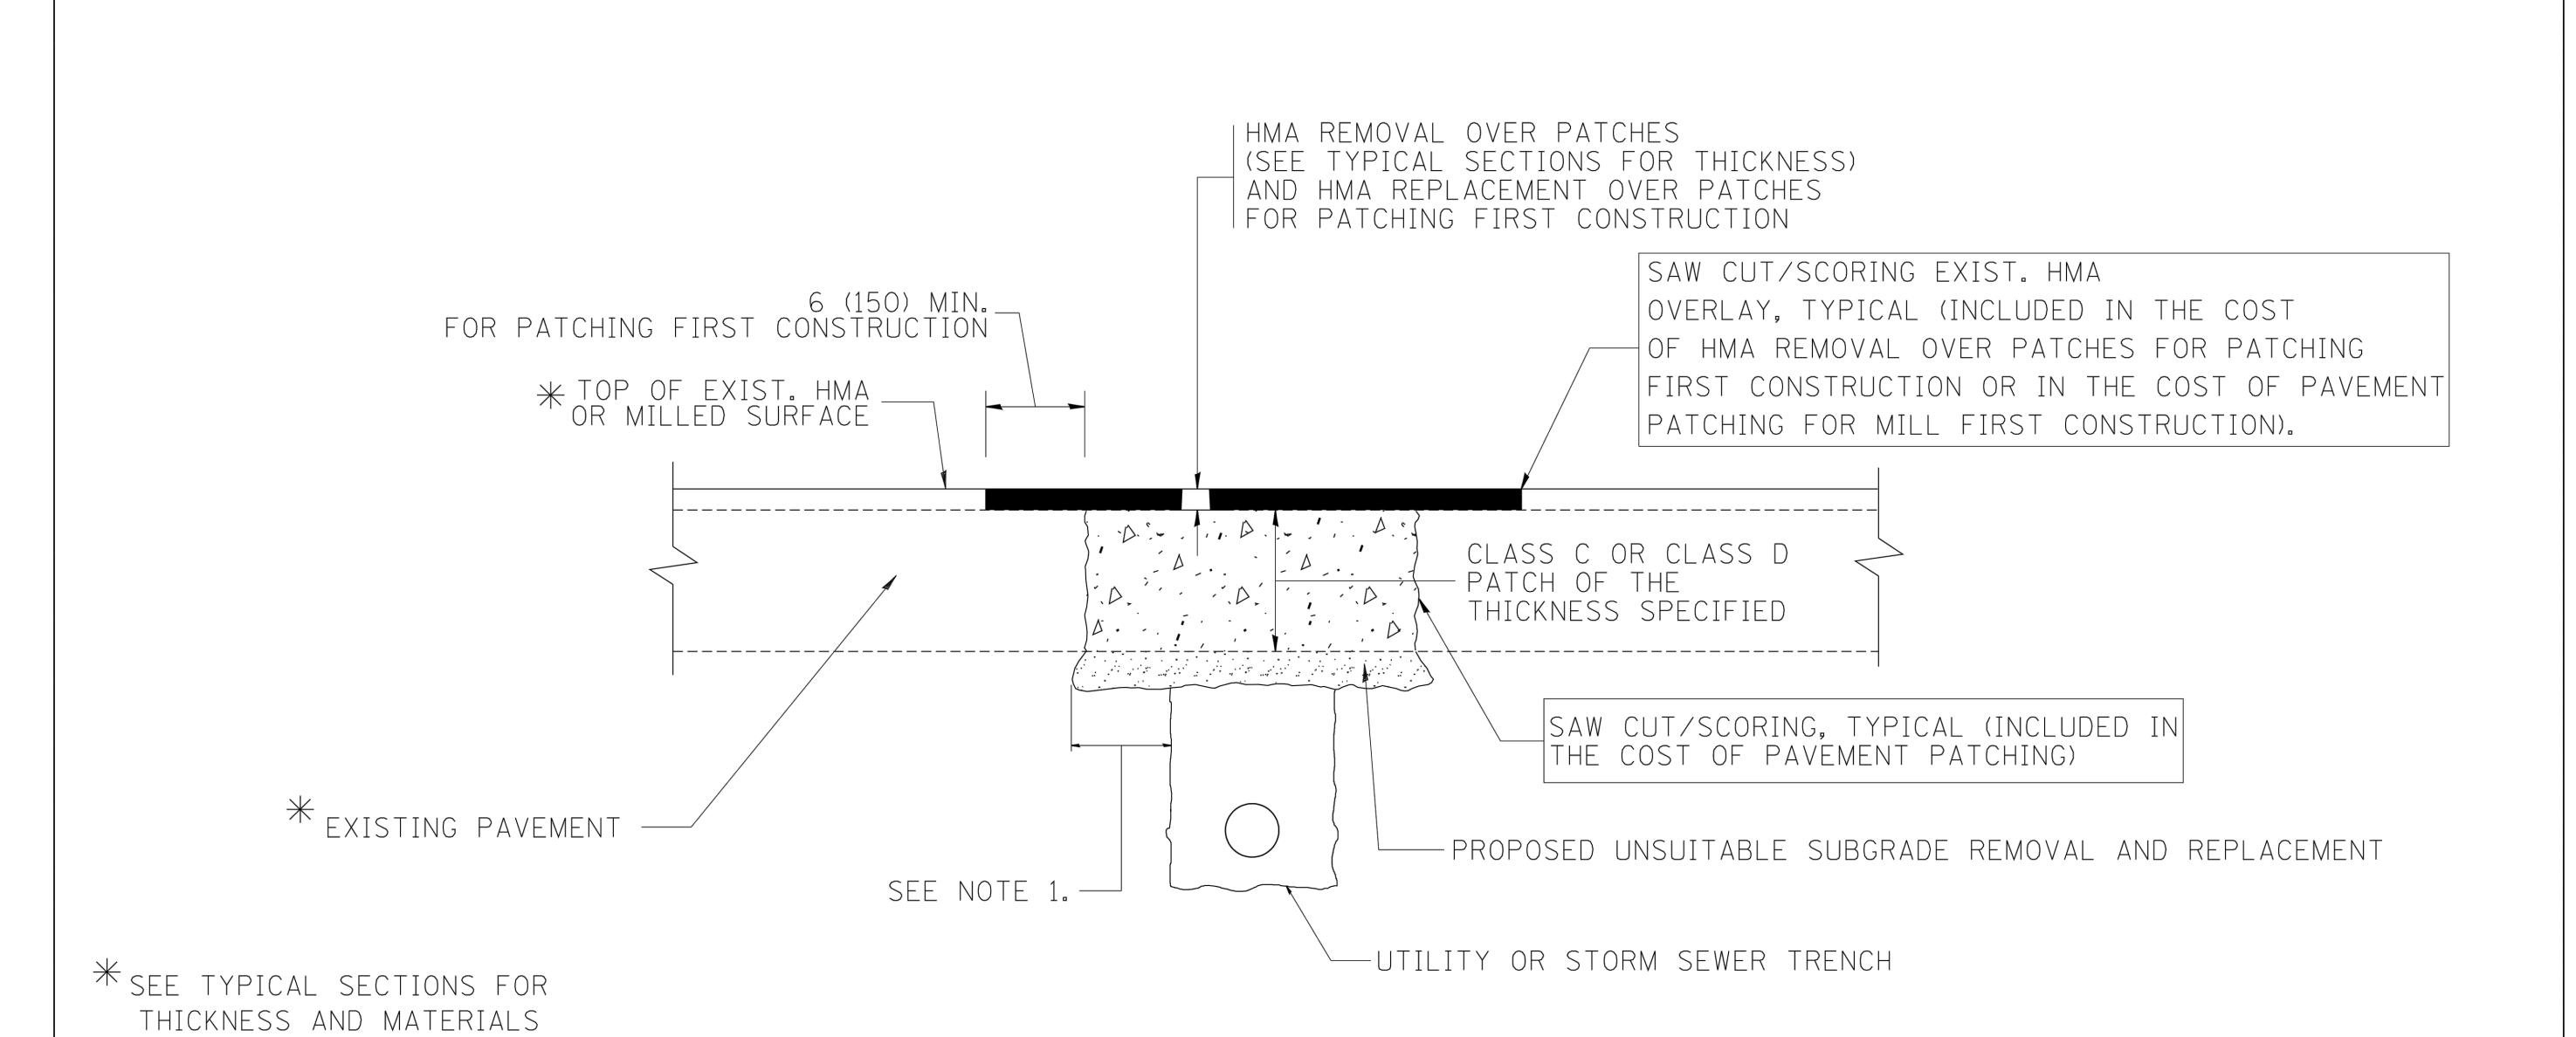

NOTES:

- 1. THE WIDTH OF THE FULL DEPTH PATCH OVER A TRENCH SHALL BE 12 (300) WIDER ON EACH SIDE OF THE TRENCH.
- 2. FOR METHOD OF MEASUREMENT AND BASIS OF PAYMENT, SEE RECURRING SPECIAL PROVISION "PATCHING WITH HOT-MIX ASPHALT OVERLAY REMOVAL".

SEQUENCE OF CONSTRUCTION (PATCHING FIRST)

- 1. REMOVE THE EXISTING HMA MATERIAL OVER THE AREA TO BE PATCHED.
- 2. REMOVE AND REPLACE WITH CLASS C OR D PATCH.
- 3. REPLACE HMA MATERIAL OVER THE AREA TO BE PATCHED.

SEQUENCE OF CONSTRUCTION (MILLING FIRST)

- 1. MILL HMA FIRST IF THERE IS AT LEAST $4\frac{1}{2}$ INCHES OR MORE OF HMA MATERIAL ON TOP OF THE EXISTING PAVEMENT OR IF THE PAVEMENT IS FULL DEPTH HMA. A MINIMUM OF 2 INCHES OF HMA MATERIAL SHALL BE IN PLACE AFTER MILLING.
- 2. REMOVE AND REPLACE WITH FULL DEPTH CLASS D PATCHES TO TOP OF MILLED SURFACE.


ALL DIMENSIONS ARE IN INCHES (MILLIMETERS) UNLESS OTHERWISE SHOWN.

FILE NAME =	USER NAME = bauerdl	DESIGNED - R. SHAH	REVISED - A. ABBAS 04-27-98		PAVEMENT PATCHING FOR		F.A. SECTION	COUNTY TOTAL SHEET
c:\projects\diststd22x34\bd22.dgn		DRAWN -	REVISED - R. BORO 01-01-07	STATE OF ILLINOIS			IVIE.	SHEETS NO.
	PLOT SCALE = 50.000 '/ IN.	CHECKED -	REVISED - R. BORO 09-04-07	DEPARTMENT OF TRANSPORTATION	HMA SURFACED PAVEMENT		BD400-04 (BD-22)	CONTRACT NO.
	PLOT DATE = 10/27/2008	DATE - 10-25-94	REVISED - K. ENG 10-27-08		SCALE: NONE SHEET NO. 1 OF 1 SHEETS STA.	TO STA.	FED. ROAD DIST. NO. 1 ILLINOIS FED.	

TO BID

TOTAL SHEET NO. CONSULTANTS REVISED -DESIGNED - ARS **CITY OF JOLIET, ILLINOIS** REVISED -DRAWN - TJB/ABN **IDOT DETAILS** BAXTER WOODMAN **MILLS ROAD WATER MAIN IMPROVEMENTS** CHECKED - LMS REVISED -18 16 **DATE –** 10–23–19 REVISED -SCALE: AS NOTED PROJECT NO: 190223.40

)LTC\190223—2020 WATER MAIN IMPR\CADD\MILLS\190223—COVER_GEN_DETS—MILLS.DWG 16 IDOT DETAILS 3/2019 10:04 AM By: 382ABN 2019. By Baxter & Woodman, Inc.

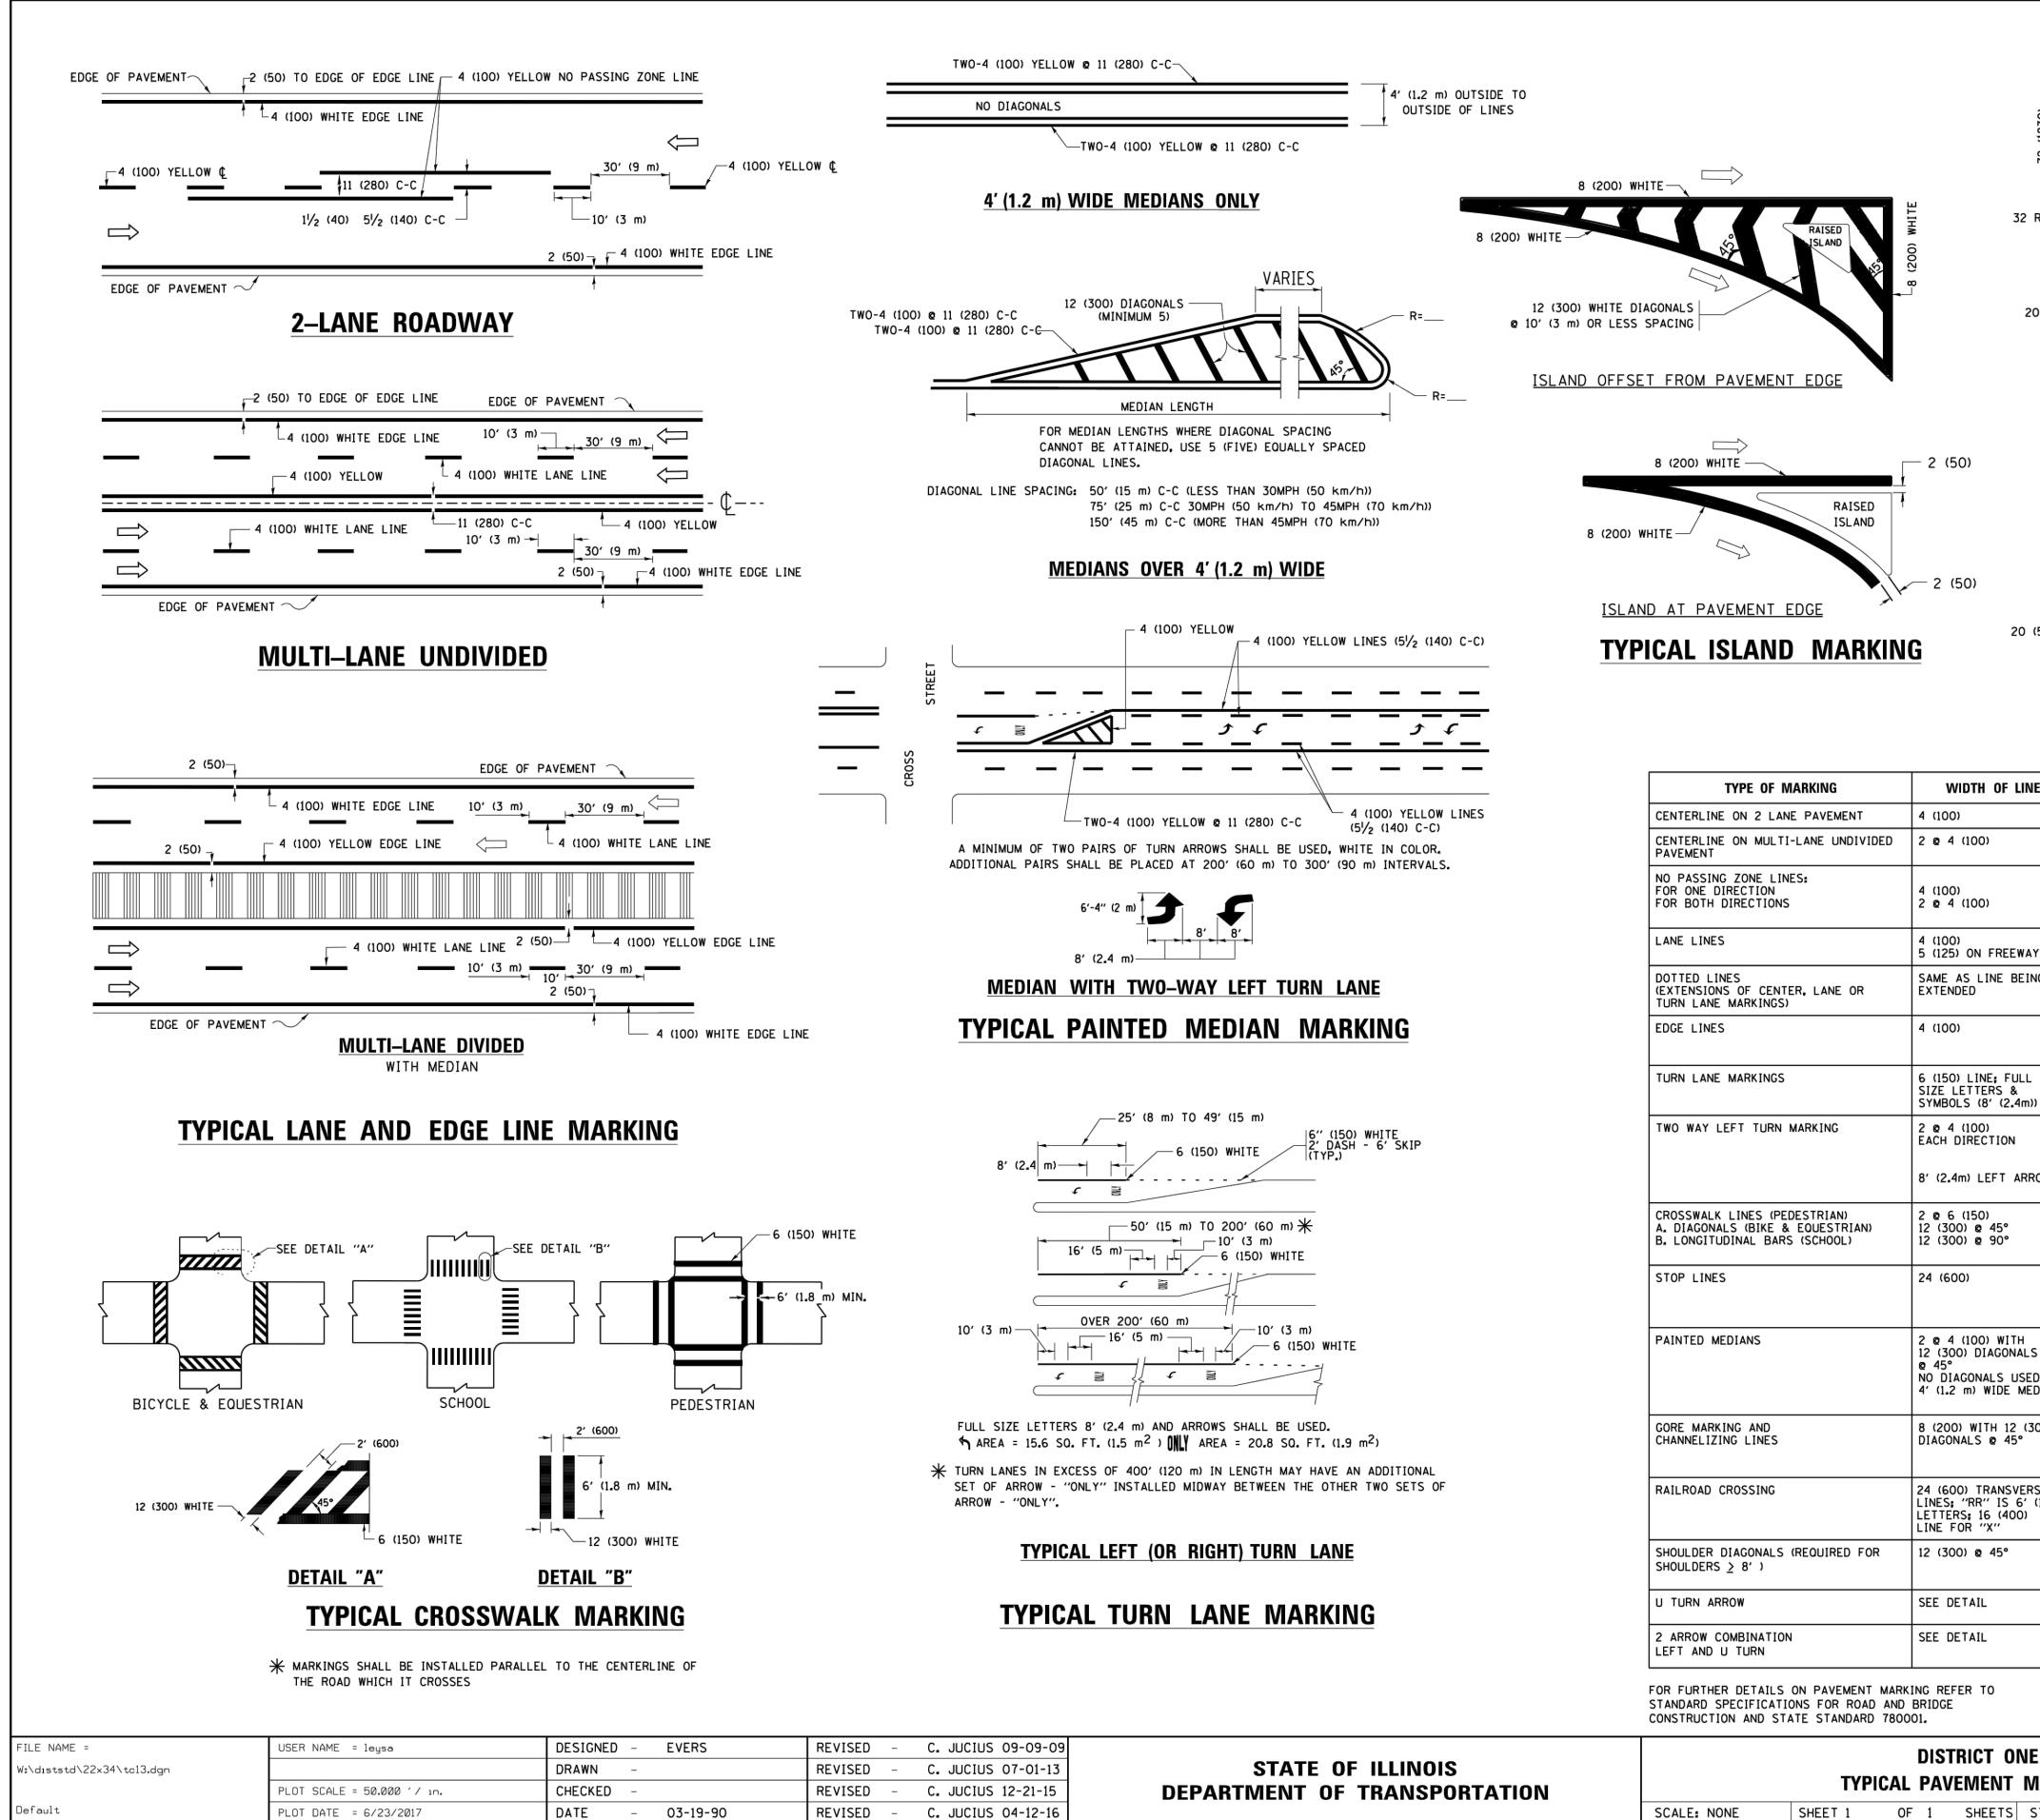

SPEED LIMIT D(FT) 425 35 500 40 580 665 50 750 55 12 (300) 40 (1020) 64 (1620) **COMBINATION** LEFT AND U-TURN 20 (510)

LANE REDUCTION TRANSITION

* LANE REDUCTION ARROWS REQUIRED AT SPEEDS OF 45 MPH OR GREATER OR WHEN SPECIFIED IN PLANS.

TYPE OF MARKING	WIDTH OF LINE	PATTERN	COLOR	SPACING /REMARKS
CENTERLINE ON 2 LANE PAVEMENT	4 (100)	SKIP-DASH	YELLOW	10' (3 m) LINE WITH 30' (9 m) SPACE
CENTERLINE ON MULTI-LANE UNDIVIDED PAVEMENT	2 @ 4 (100)	SOLID	YELLOW	11 (280) C-C
NO PASSING ZONE LINES: FOR ONE DIRECTION FOR BOTH DIRECTIONS	4 (100) 2 @ 4 (100)	SOL ID SOL ID	YELLOW YELLOW	5½ (140) C-C FROM SKIP-DASH CENTERLINE 11 (280) C-C OMIT SKIP-DASH CENTERLINE BETWEEN
LANE LINES	4 (100) 5 (125) ON FREEWAYS	SKIP-DASH SKIP-DASH	WHITE WHITE	10' (3 m) LINE WITH 30' (9 m) SPACE
DOTTED LINES (EXTENSIONS OF CENTER, LANE OR TURN LANE MARKINGS)	SAME AS LINE BEING EXTENDED	SKIP-DASH	SAME AS LINE BEING EXTENDED	2' (600) LINE WITH 6' (1.8 m) SPACE
EDGE LINES	4 (100)	SOLID	YELLOW-LEFT WHITE-RIGHT	OUTLINE MEDIANS IN YELLOW
TURN LANE MARKINGS	6 (150) LINE; FULL SIZE LETTERS & SYMBOLS (8' (2.4m))	SOLID	WHITE	SEE TYPICAL TURN LANE MARKING DETAIL
TWO WAY LEFT TURN MARKING	2 @ 4 (100) EACH DIRECTION 8' (2.4m) LEFT ARROW	SKIP-DASH AND SOLID IN PAIRS	YELLOW	10' (3 m) LINE WITH 30' (9 m) SPACE FOR SKIP-DASH; 51/2 (140) C-C BETWEEN SOLID LINE AND SKIP-DASH LINE SEE TYPICAL TWO-WAY LEFT TURN MARKING DETAIL
CROSSWALK LINES (PEDESTRIAN) A. DIAGONALS (BIKE & EQUESTRIAN) B. LONGITUDINAL BARS (SCHOOL)	2 @ 6 (150) 12 (300) @ 45° 12 (300) @ 90°	SOLID SOLID SOLID	WHITE WHITE WHITE	NOT LESS THAN 6' (1.8 m) APART 2' (600) APART 2' (600) APART SEE TYPICAL CROSSWALK MARKING DETAILS.
STOP LINES	24 (600)	SOLID	WHITE	PLACE 4' (1.2 m) IN ADVANCE OF AND PARALLEL TO CROSSWALK, IF PRESENT. OTHERWISE, PLACE AT DESIRED STOPPING POINT. PARALLEL TO CROSSROAD CENTERLINE, WHERE POSSIBLE
PAINTED MEDIANS	2 @ 4 (100) WITH 12 (300) DIAGONALS @ 45° NO DIAGONALS USED FOR 4' (1.2 m) WIDE MEDIANS	SOLID	YELLOW: TWO WAY TRAFFIC WHITE: ONE WAY TRAFFIC	11 (280) C-C FOR THE DOUBLE LINE SEE TYPICAL PAINTED MEDIAN MARKING.
GORE MARKING AND CHANNELIZING LINES	8 (200) WITH 12 (300) DIAGONALS @ 45°	SOLID	WHITE	DIAGONALS: 15' (4.5 m) C-C (LESS THAN 30MPH (50 km/h)) 20' (6 m) C-C 30MPH (50 km/h) TO 45MPH (70 km/h)) 30' (9 m) C-C (OVER 45MPH (70 km/h))
RAILROAD CROSSING	24 (600) TRANSVERSE LINES: "RR" IS 6' (1.8 m) LETTERS: 16 (400) LINE FOR "X"	SOLID	WHITE	SEE STATE STANDARD 780001 AREA OF: "R"=3.6 SO. FT. (0.33 m ²) EACH "X"=54.0 SO. FT. (5.0 m ²)
SHOULDER DIAGONALS (REQUIRED FOR SHOULDERS > 8')	12 (300) @ 45°	SOLID	WHITE - RIGHT YELLOW - LEFT	50' (15 m) C-C (LESS THAN 30MPH (50 km/h)) 75' (25 m) C-C (30 MPH (50 km/h) T0 45MPH (70 km/h) 150' (45 m) C-C (0VER 45MPH (70 km/h))
U TURN ARROW	SEE DETAIL	SOLID	WHITE	16.3 SF
2 ARROW COMBINATION	SEE DETAIL	SOLID	WHITE	30.4 SF

[']40 (1020) [']

FOR FURTHER DETAILS ON PAVEMENT MARKING REFER TO

AS NOTED

SCALE:

All dimensions are in inches (millimeters) unless otherwise shown.

			DIS	TRICT O	NE		F.A. RTE.	SECTION	COUNTY	TOTAL SHEETS	SHEET NO.
1		TYPI	CAL PAI	/EMENT	MARKINGS	3		TC-13	CONTRACT	NO.	
	SCALE: NONE	SHEET 1	OF 1	SHEETS	STA.	TO STA.		ILLINOIS FED. A			

TO BID

WOODMAN BAXTER

CONSULTANTS REVISED -REVISED -REVISED -REVISED -

CITY OF JOLIET, ILLINOIS MILLS ROAD WATER MAIN IMPROVEMENTS


IDOT DETAILS

PROJECT NO:

190223.40

TOTAL SHEET NO. DESIGNED - ARS DRAWN - TJB/ABN CHECKED - LMS

18 17 **DATE -** 10-23-19

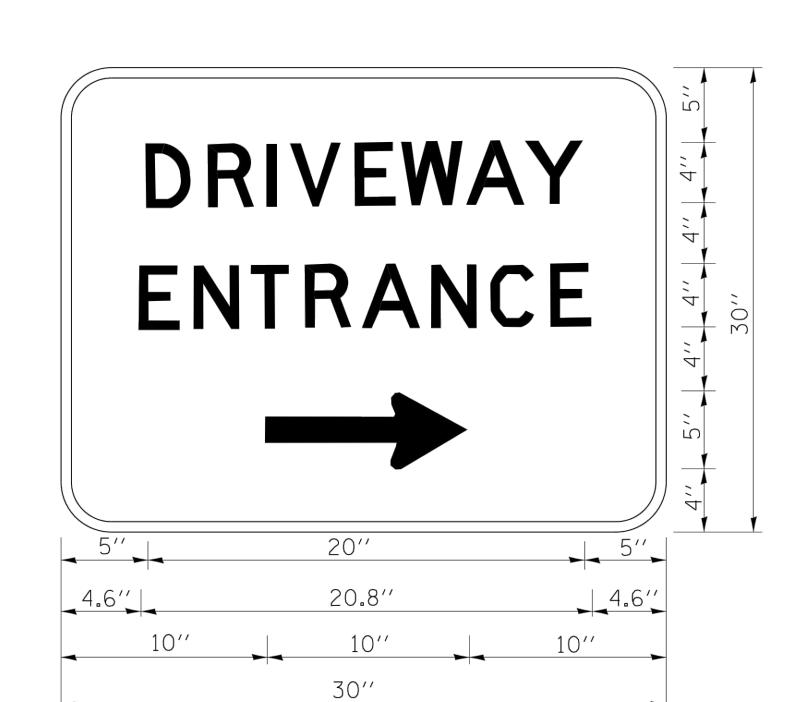

3.0" RADIUS, 0.5" BORDER, WHITE ON GREEN; REFLECTORIZED "DRIVEWAY" D; "ENTRANCE" D; STANDARD ARROW CUSTOM 12.0" x 5.0"

NOTES:

- 1. HALF OF THE SIGNS WILL REQUIRE A LEFT HAND FACING ARROW.
- 2. TWO SIGNS SHALL BE USED AT EACH COMMERCIAL ENTRANCE PLACED BACK-TO-BACK: ONE WITH A RIGHT HAND ARROW (SHOWN) SHALL BE PLACED ON THE NEAR RIGHT SIDE THE DRIVEWAY AND ONE WITH A LEFT HAND ARROW SHALL BE PLACED ON THE FAR LEFT SIDE OF THE DRIVEWAY.
- 3. SIGNS TO BE PAID FOR AS ITEM "TEMPORARY INFORMATION SIGNING".

FILE NAME =	USER NAME = gaglianobt	DESIGNED -	REVISED -	C. JUCIUS 02-15-07
c:\pw_work\pwidot\gaglianobt\d0108315\tc	26.dgn	DRAWN -	REVISED -	
	PLOT SCALE = 50.000 '/ in.	CHECKED -	REVISED -	
	PLOT DATE = 12/13/2012	DATE -	REVISED -	

STATE OF ILLINOIS **DEPARTMENT OF TRANSPORTATION**

SECTION **DRIVEWAY ENTRANCE SIGNING** TC-26 SCALE: NONE TO STA. SHEET NO. 1 OF 1 SHEETS STA.

COUNTY TOTAL SHEET NO. CONTRACT NO. FED. ROAD DIST. NO. 1 | ILLINOIS | FED. AID PROJECT

tc26.dgn 12/13/2012 3:26:37 PM User=gaglianobt

TO BID

SAXTER WOODMAN
Consulting Engineers

CONSULTANTS REVISED -REVISED -REVISED -REVISED -

CITY OF JOLIET, ILLINOIS MILLS ROAD WATER MAIN IMPROVEMENTS

IDOT DETAILS

TOTAL SHEET NO. DRAWN - TJB/ABN CHECKED — LMS 18 18 **DATE –** 10–23–19

PROJECT NO: 190223.40

AS NOTED

SCALE: